## **LEGEND**

	DOMESTIC COLD WATER
	DOMESTIC HOT WATER
	DOMESTIC HOT WATER RETURN
	SANITARY SEWER
	VENT
<del></del>	PIPE DOWN
	PIPE DOWN PIPE UP
——⊸o	
——  ——  ——  ——  ——  ——  ——  ——  ——  ——	PIPE UP

DETAIL NUMBER-DRAWING WHERE CALLOUT IS REFERENCED FROM-

W/

WH WHA

WRT

CALLOUT HEAD

PLUMBING PLAN NOTE

STRAINER

DRAWING WHERE CALLOUT IS SHOWN-

<b>ABBREVIATIONS</b>	
ABV AFF ASJ CLG CO	ABOVE ABOVE FINISHED FLOOR ALL SERVICE JACKET CEILING CLEANOUT CIRCUIT SETTER
CV CW DEG. F DN DWH	CHECK VALVE DOMESTIC COLD WATER DEGREES FAHRENHEIT DOWN DOMESTIC WATER HEATER
EWC FCO FD FR	ELECTRIC WATER COOLER FLOOR CLEANOUT FLOOR DRAIN FROM
FSK GA GND GPH	FOIL SCRIM KRAFT GAUGE GROUND GALLONS PER HOUR
GPM HB HP HW	GALLONS PER MINUTE HOSE BIBB HORSEPOWER DOMESTIC HOT WATER
HWR LVG MAX MFR	DOMESTIC HOT WATER RETURN LEAVING MAXIMUM MANUFACTURER
MIN NC NO NTS OPG	MINIMUM NORMALLY CLOSED NORMALLY OPEN NOT TO SCALE OPENING
PDI SAN TPV VTR	PLUMBING & DRAINAGE INSTITUTE SANITARY SEWER TRAP PRIMER VALVE VENT TRHOUGH ROOF
	14 UT. I

WALL HYDRANT

WROUGHT

WATER HAMMER ARRESTOR

## **GENERAL NOTES**


- INSTALLATION SHALL BE IN STRICT ACCORDANCE WITH THE UNIFORM STATEWIDE BUILDING CODE, INCLUDING REFERENCED CODES AND STANDARDS AND IN ACCORDANCE WITH MANDATES OF THE LOCAL BUILDING OFFICALS.
- THE GENERAL ARRANGEMENT AND LOCATIONS OF PIPING, FIXTURES, ETC. ARE INDICATED BY THE DRAWINGS AND SHALL BE INSTALLED IN ACCORDANCE THEREWITH, WITH THE EXCEPTION OF SUCH CHANGES AS MAY BE REQUIRED ON ACCOUNT OF OTHER TRADES. CONTRACTOR SHALL COORDINATE WORK WITH INSTALLATION OF OTHER SUBCONTRACTORS.
- PLUMBING WORK SHALL BE COORDINATED WITH THE CONTRACTOR AS TO SCHEDULING, DIMENSIONING AND LOCATION OF EQUIPMENT.
- MAJOR ITEMS ARE SHOWN ON THE PLANS. THE CONTRACTOR SHALL BE RESPONSIBLE FOR ALL INCIDENTAL ITEMS REQUIRED TO PROVIDE A COMPLETE AND FUNCTIONAL
- SUBSTITUTION FOR SPECIFIED ITEMS SHALL BE BORNE BY THE CONTRACTOR.

ALL REQUIRED WALL OR FLOOR OPENINGS SHALL BE COORDINATED WITH THE


ALL PIPING SHALL BE ABOVE CEILING UNLESS INDICATED OTHERWISE.

CONTRACTOR.


- ALL EQUIPMENT SHALL BE WIPED CLEAN, REMOVING ALL TRACES OF OIL, DIRT, OR
- PROVIDE SUPPORTS TO RIGIDLY ATTACH ALL EQUIPMENT, APPURTENANCES AND PIPE AS REQUIRED FOR SUPPORT. PRIOR TO INSTALLATION OF HANGERS AND INSERTS, THE CONTRACTOR SHALL COORDINATE LOCATIONS AND EQUIPMENT TO MINIMIZE CONFLICTS WITH OTHER BUILDING SYSTEMS.
- CONTRACTOR SHALL MAKE FINAL CONNECTIONS TO ALL EQUIPMENT INDICATED TO BE FURNISHED BY OTHERS.
- ALL PIPE OF THE SAME SIZE SHALL BE OF THE SAME MATERIAL.
- SLOPE ALL DRAIN LINES 1/4 INCH PER FOOT MINIMUM FOR SIZES LESS THAN 4 INCHES, SLOPE 1/8 INCH PER FOOT SIZES 4 INCHES AND LARGER UNLESS INDICATED OTHERWISE BY INVERTS ON DWGS.
- SOIL, WASTE AND VENT PIPING LOCATED BELOW GRADE SHALL BE MINIMUM 2 INCHES.
- VENTS SHALL EXTEND 12 INCHES ABOVE ROOF. ROOF FLASHING SHALL BE COORDINATED BY THE CONTRACTOR.
- DOMESTIC HOT AND COLD WATER PIPING SHALL BE 1/2 INCH SIZE UNLESS INDICATED
- BALL VALVES MAY BE USED IN LIEU OF GATE VALVES 2 INCHES OR SMALLER.
- ALL EXPOSED FIXTURE SUPPLIES AND WASTE LINES SHALL BE CHROME PLATED.
- R. INSTALL ALL FIXTURES AND EQUIPMENT PER MANUFACTURER'S RECOMMENDATIONS.

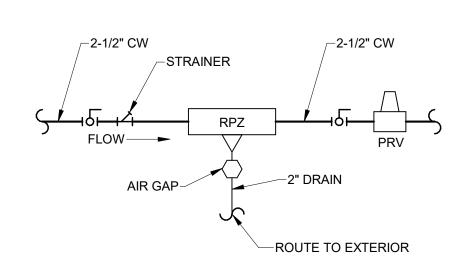

# RPZ DETAIL

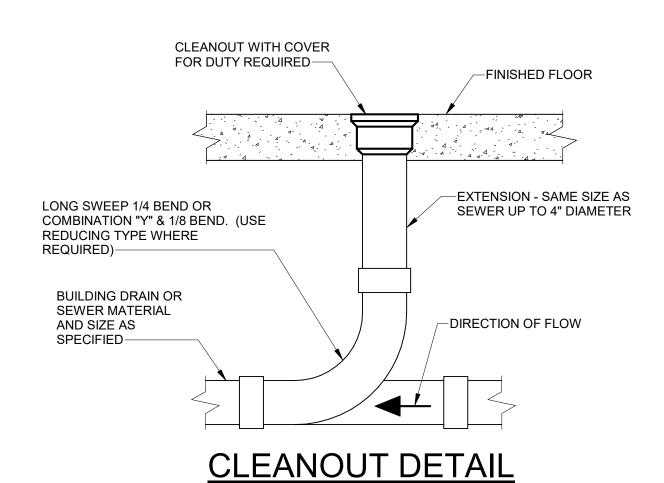

### PLUMBING FIXTURE SCHEDULE **CONNECTION SIZES** MANUFACTURER SUPPLY FITTINGS DESIGNATION **FIXTURE** SIZE TRAP CARRIER REMARKS & ACCESSORIES & MODEL AND STOPS COMPLIANT WASTE HOT COLD AMERICAN FLUSH VALVE: SLOAN MODEL G2 8111-1.6 WATER INTEGRAL STANDARD MOUNTED SEAT: AMERICAN STANDARD 5901.100 CLOSET 3351.101 AMERICAN WATER FLUSH VALVE: SLOAN MODEL G2 8111-1.6 P-1A YES INTEGRAL STANDARD MOUNTED SEAT: AMERICAN STANDARD 5901.100 CLOSET 3351.101 AMERICAN INTEGRAL FLUSH VALVE: SLOAN G2 8186-1.0 URINAL YES 3/4" STANDARD MOUNTED 6590.001EC AMERICAN 1 1/2" 17 GA COUNTER 19-1/8" ROUND 3/8" ANGLE STOPS FAUCET: SLOAN MODEL ETF600-LT-BA WITH GRID STRAINER. YES LAVATORY STANDARD 1 1/2" 1/2" P-TRAP MOUNTED 0490.011 1 1/2" 17 GA ELKAY COUNTER 33" X 22" 3/8" ANGLE STOPS NO KITCHEN SINK FAUCET: ZURN Z82300-XL-CP8-HS. 1.0 GPM MAX. 1/2" 1 1/2" P-TRAP LRAD332165PD MOUNTED WITH FIAT 830AA WITH MODEL 832AA HOSE & HOSE BRACKET, FLOOR 36" X 36" X 12" 3" P-TRAP JANITOR SINK STAINLESS STEEL MOP HANGER & MODEL MSG2424 WALL 1/2" TSB3012 MOUNTED GUARDS. **ELECTRIC** ELKAY WALL **BI-LEVEL** 3/8" ANGLE STOPS YES WITH BOTTLE FILLING STATION. 1 1/2" LZSTL8WSLK P-TRAP MOUNTED WATER COOLER

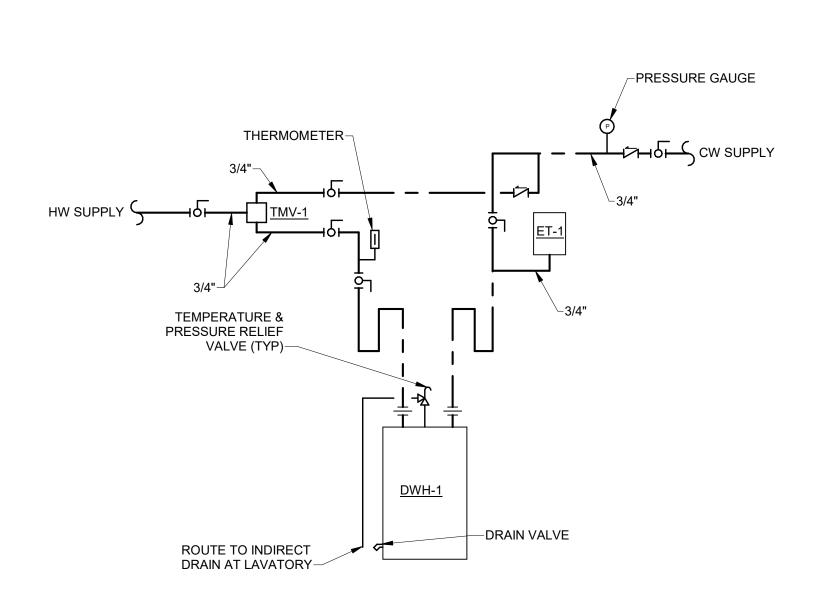


### DOMESTIC WATER HEATER DETAIL NOT TO SCALE

NOTE: SUPPORT SHELF TO BE ALL WELDED CONSTRUCTION DWH-1 4"x4"x3/16" FRAME WITH 1" THICK PAINTED WOOD BOTTOM DRIP PAN TO BE 16 GA. ALL SOLDERED JOINTS-1 1/4" x 1 1/4" x 1/4" (2 REQUIRED)-1/2" DRIP PAN DRAIN PIPE TO INDIRECT DRAIN AT BACK OF LAVATORY-ANCHORS, BACKPLATE, AND FRAMING TO SUIT WALL CONSTRUCTION-

DOMESTIC WATER HEATER WALL MOUNTING DETAIL


MISC	MISCELLANEOUS EQUIPMENT SCHEDULE	
MARK	DESCRIPTION	
DWH-1	DOMESTIC WATER HEATER - A.O. SMITH DEL-30 WITH 30 GALLON TANK, 4/4 KW SIMULTANEOUS INPUT (8 KW TOTAL), 32 GPH RECOVERY AT 100 DEG.F RISE, 208V/1PH/60HZ	
DWH-2	INSTANTANEOUS ELECTRIC DOMESTIC WATER HEATER - CHRONOMITE SR-40/208 WITH 8320 WATT INPUT AND 0.65 GPM ACTIVATION. INSTALL PER MANUFACTURER'S RECOMMENDATIONS.	
ET-1	THERMAL EXPANSION TANK - AMTROL MODEL ST-5-C WITH 0.9 GALLONS ACCEPTANCE VOLUME.	
FCO	FLOOR CLEANOUT - JOSAM 55000 SERIES. LINE SIZED.	
FD-1	3" FLOOR DRAIN - JOSAM 30000-A SERIES CAST IRON FLOOR DRAIN WITH TRAP SEAL INSERT.	
IMB	ICE MAKER CONNECTION BOX - OATEY MODEL I2K LOW LEAD WITH PLASTIC FACEPLATE AND QUARTER-TURN BRASS BALL VALVE.	
PRV	PRESSURE REDUCING VALVE - WATTS MODEL LF223 WITH STRAINER.	
RPZ-1	2 1/2" REDUCED PRESSURE ZONE ASSEMBLY - WATTS MODEL LF009. LEAD FREE. PROVIDE WITH AIR GAP, STRAINER AND SHUT-OFF VALVES.	
TMV-1	THERMOSTATIC MXING VALVE - LEONARD MODEL TM-26-LF WITH 3/4" INLETS AND OUTLET.	
TPV	TRAP PRIMER VALVE - PRECISION PLUMBING PRODUCTS PR-500 WITH 1/2" COPPER LINE.	
wco	WALL CLEANOUT - JOSAM 58600-CO SERIES	
WH	FREEZELESS WALL HYDRANT - WOODFORD MODEL B65.	
WHA-"X"	SHOCK ABSORBER, JOSAM SERIES 75000-S.  MODEL NUMBER 75000-S 75001-S 75002-S 75003-S 75004-S  P.D.I. AA A B C D  FIXTURE UNITS 1 1-11 12-32 33-60 61-113	

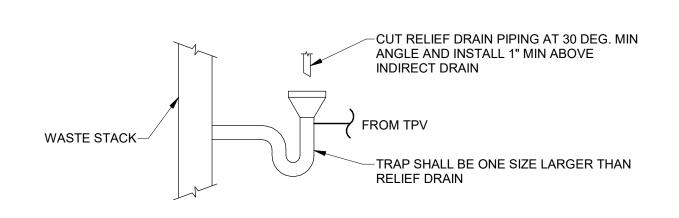

**INDIRECT DRAIN DETAIL** 

NOT TO SCALE



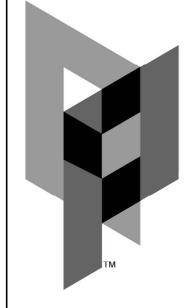

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GF


WORK

**BID SET** 

DATE:

11/10/21 DESIGNED: WJC DRAWN: WJC CHECKED: REVISIONS:

LEGEND, **NOTES AND** ABBREVIATIONS

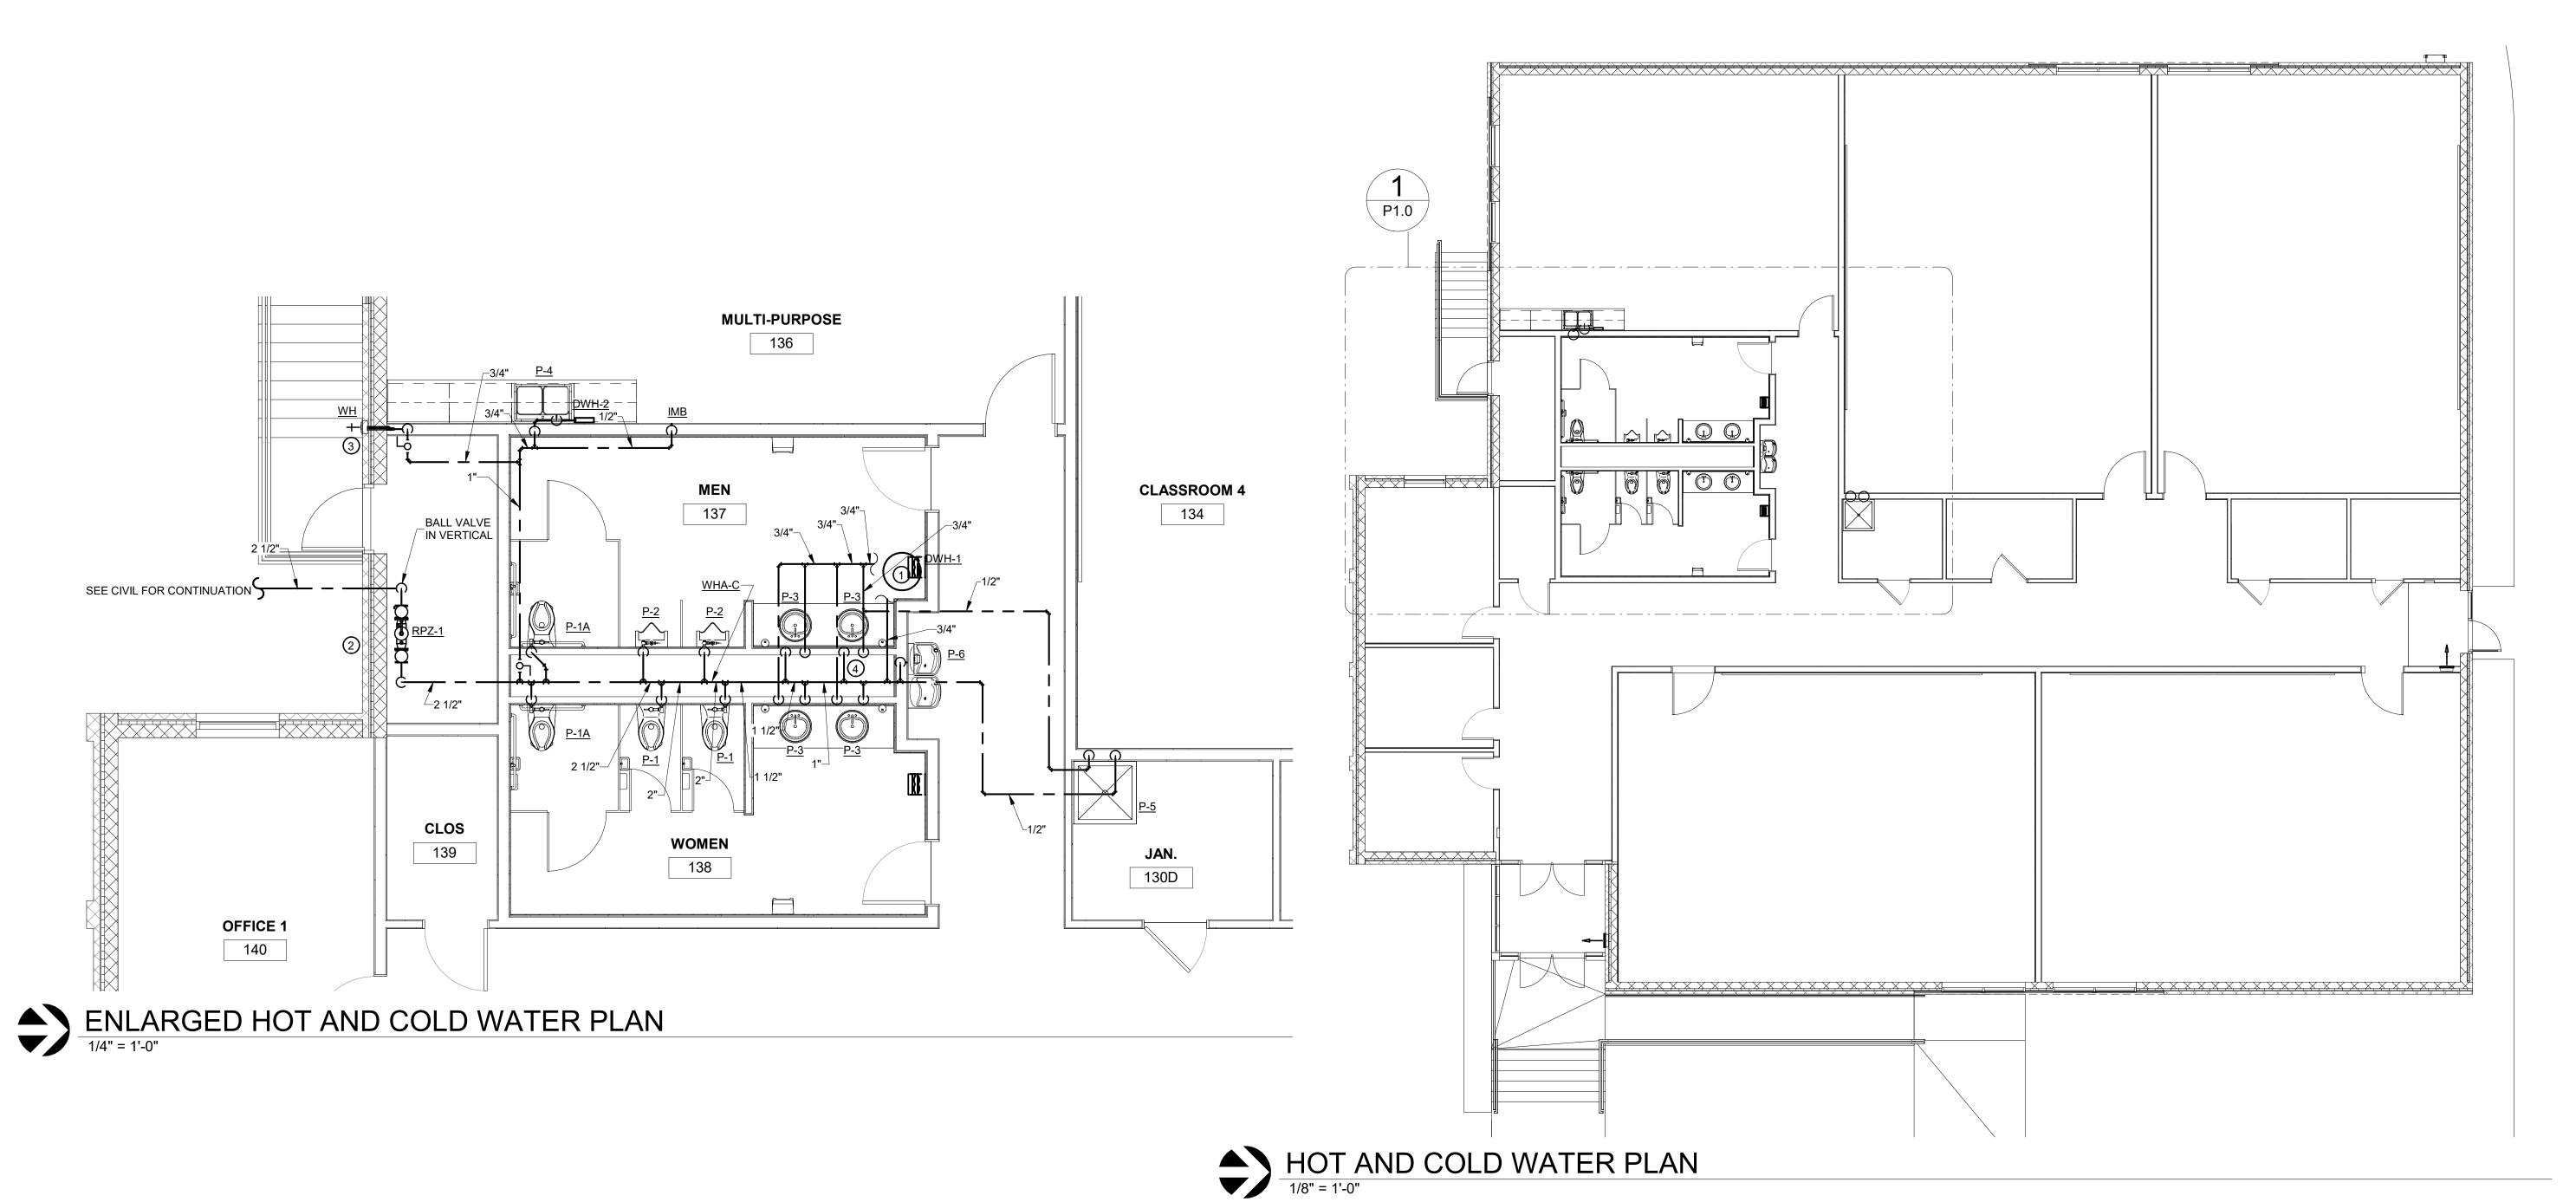

## PLAN NOTES


- MOUNT DWH-1 ABOVE CEILING IN MEN'S ROOM. SEE MOUNTING DETAIL. ROUTE RELIEF DRAIN AND DRIP PAN DRAIN TO INDIRECT DRAIN AT LAVATORY. SEE SANITARY AND VENT PLAN.
- 2 ROUTE DRAIN FROM RPZ-1 THROUGH EXTERIOR WALL AND DOWN TO GRADE. TERMINATE AT SPLASHBLOCK IN THIS LOCATION. SEAL WALL PENETRATION WATER-TIGHT.
- MOUNT WALL HYDRANT AT HEIGHT SUITABLE FOR USE.
- PROVIDE TPV IN THIS LOCATION. CONNECT TO INDIRECT DRAIN.

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CENTER WORK




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DESIGNED: DRAWN: CHECKED: REVISIONS:

RDC

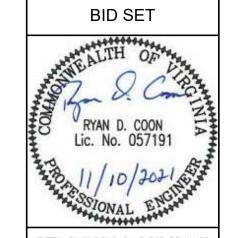RDC

**PLUMBING HOT AND** COLD WATER **PLANS** 

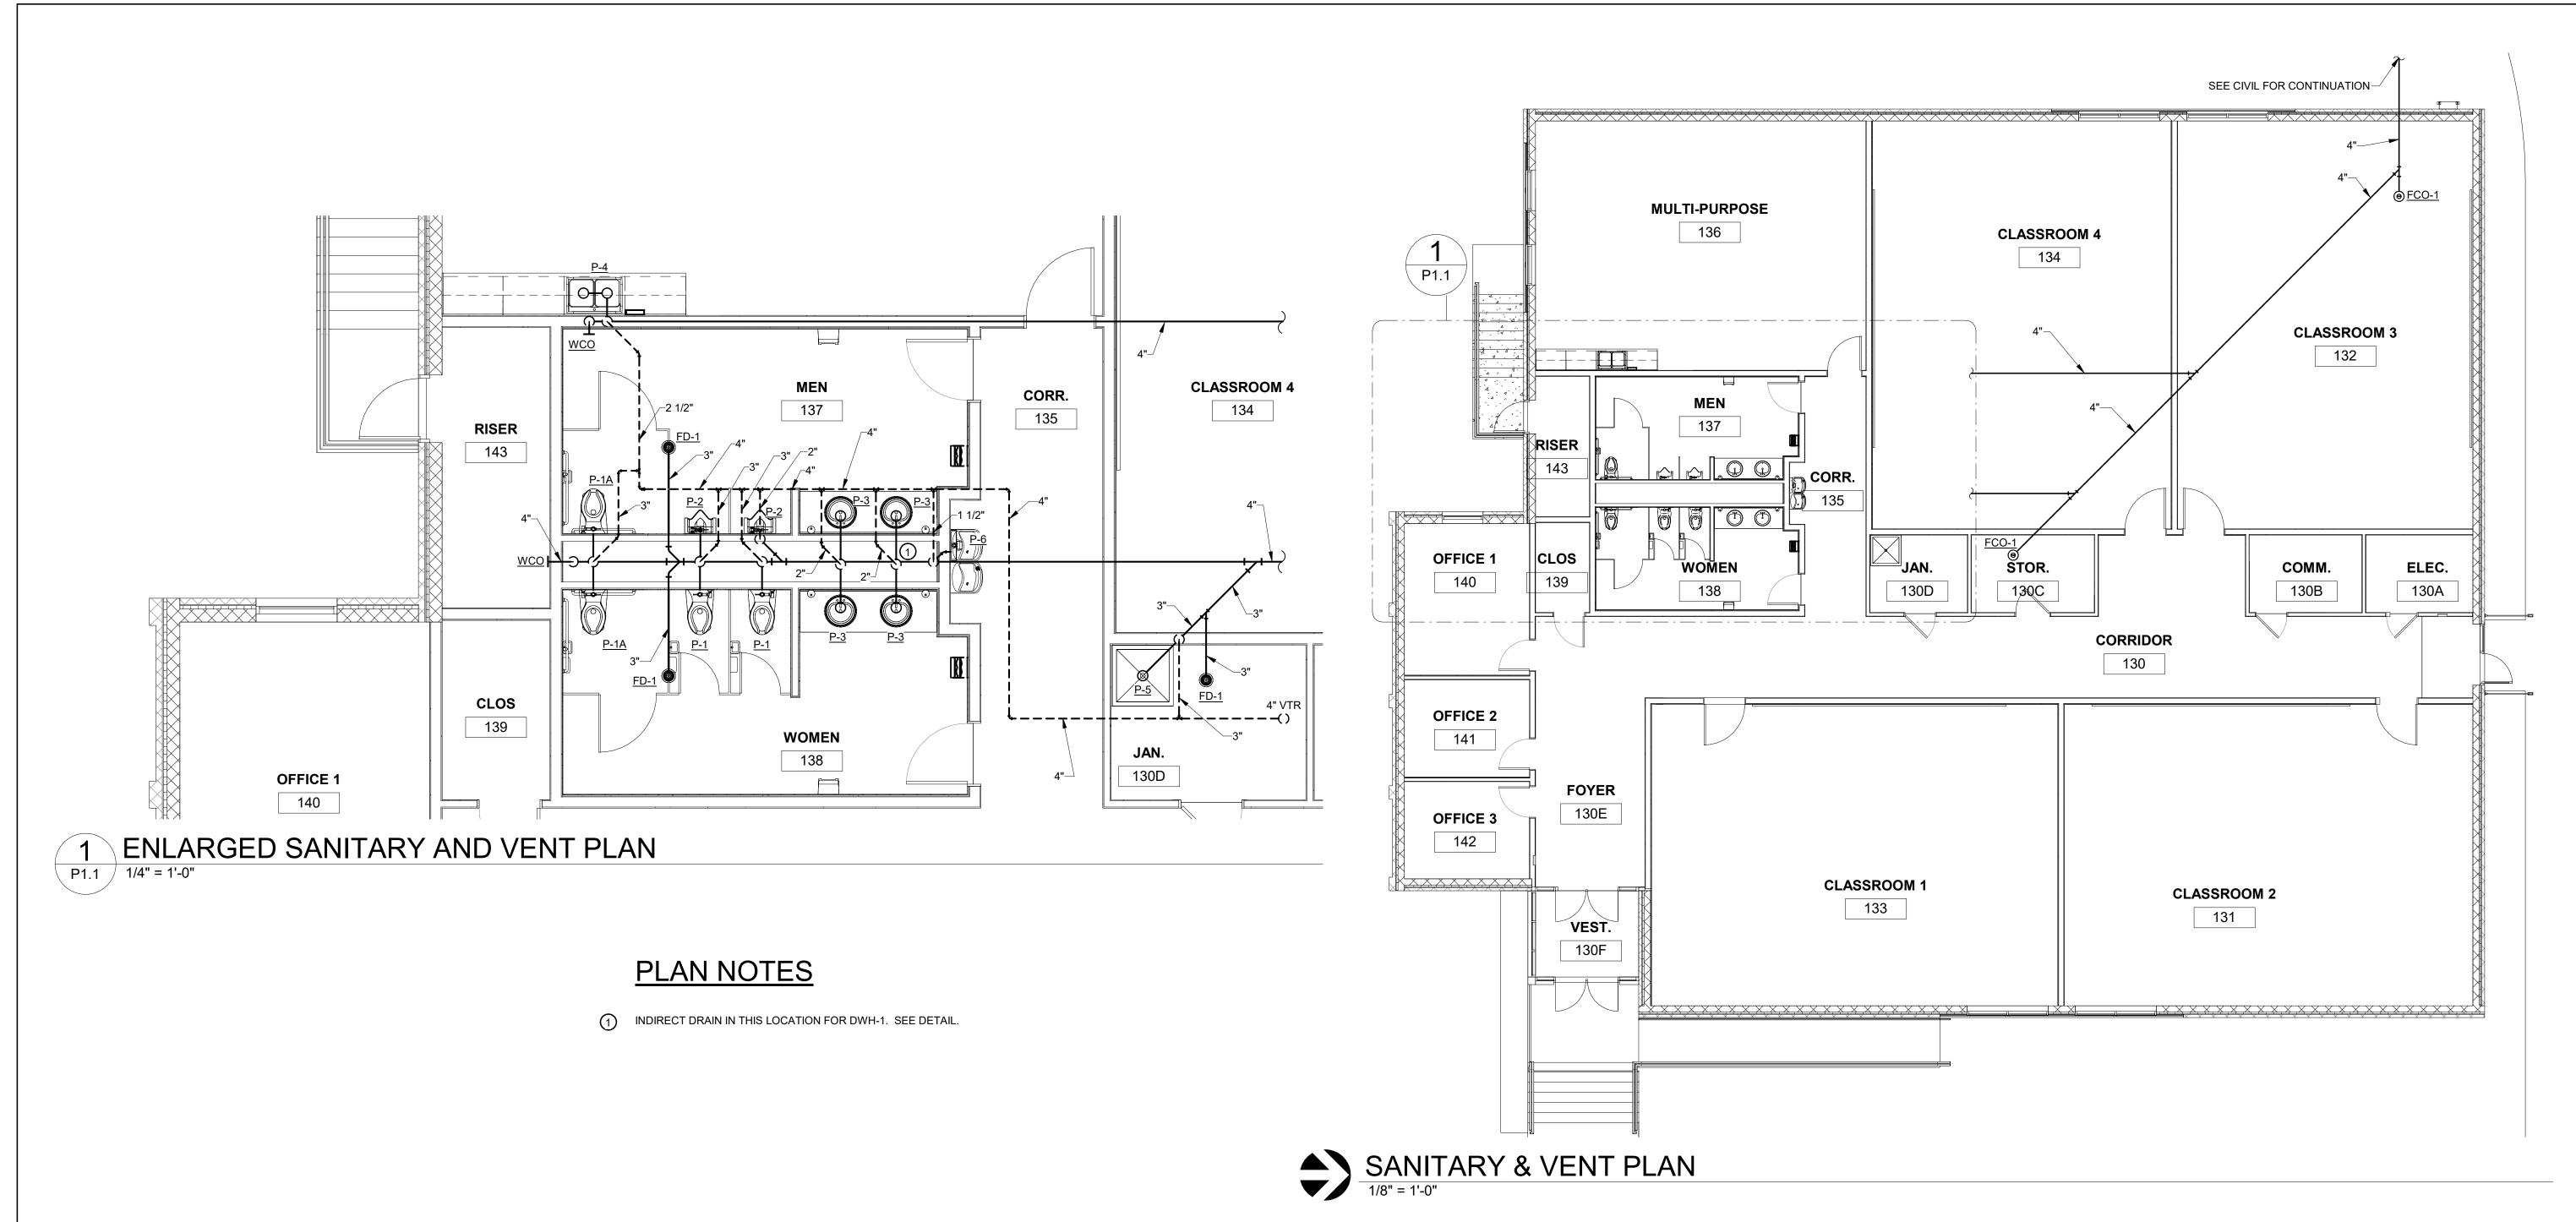

WORKFORCE TRANI GREENFIELD


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RID S



WRITTEN DIMENSIONS ON THESE DRAWINGS SHALL TAKE PRECEDENCE OVER SCALED DIMENSIONS. CONTRACTORS SHALL VERIFY AND BE RESPONSIBLE FOR ALL DIMENSIONS AND CONDITIONS ON THE JOB AND THIS OFFICE MUST BE NOTIFIED OF ANY VARIATION FROM THE DIMENSIONS AND CONDITIONS SHOWN BY THESE DRAWINGS

DATE: 11/10/21

RDC

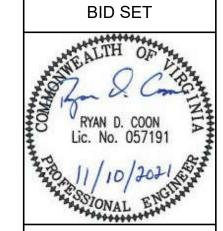
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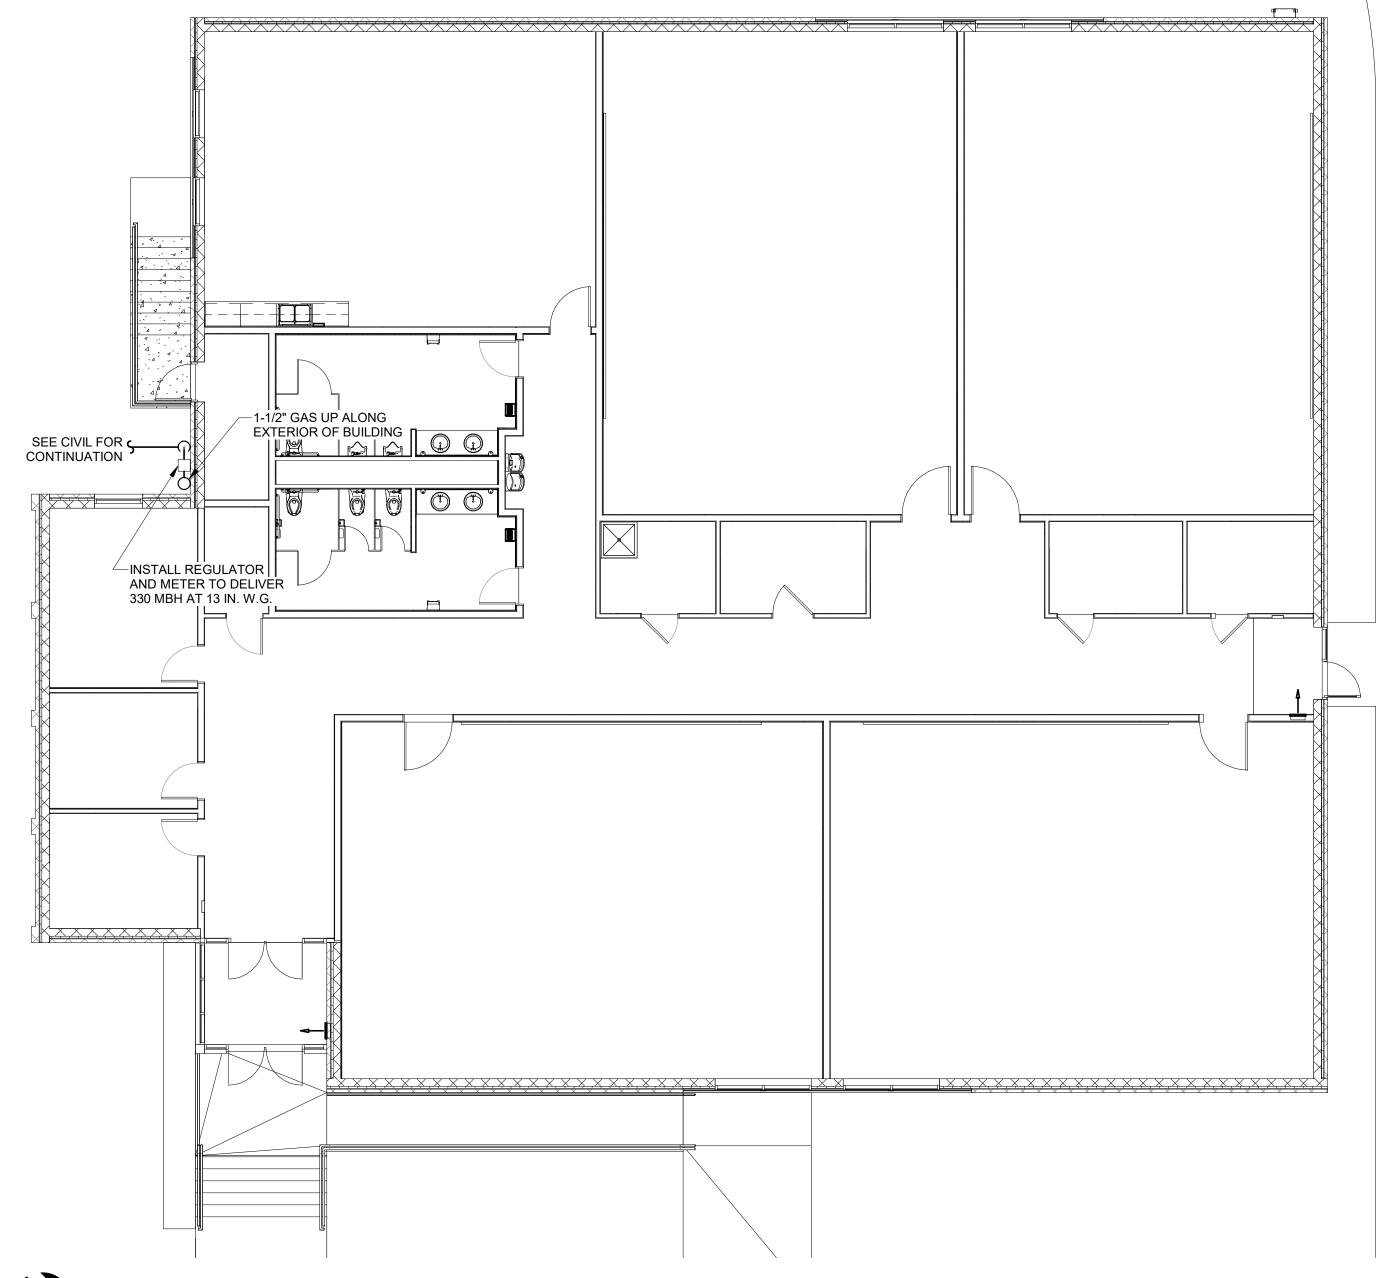
RDC

DATE:
DESIGNED:
DRAWN:
CHECKED:
REVISIONS:

PLUMBING SANITARY AND VENT PLANS

MASTER ENGINEERS & DESIGNERS 904 Lakeside Drive, Lynchburg, VA 24501 434-846-1350 Fax: 434-846-1351



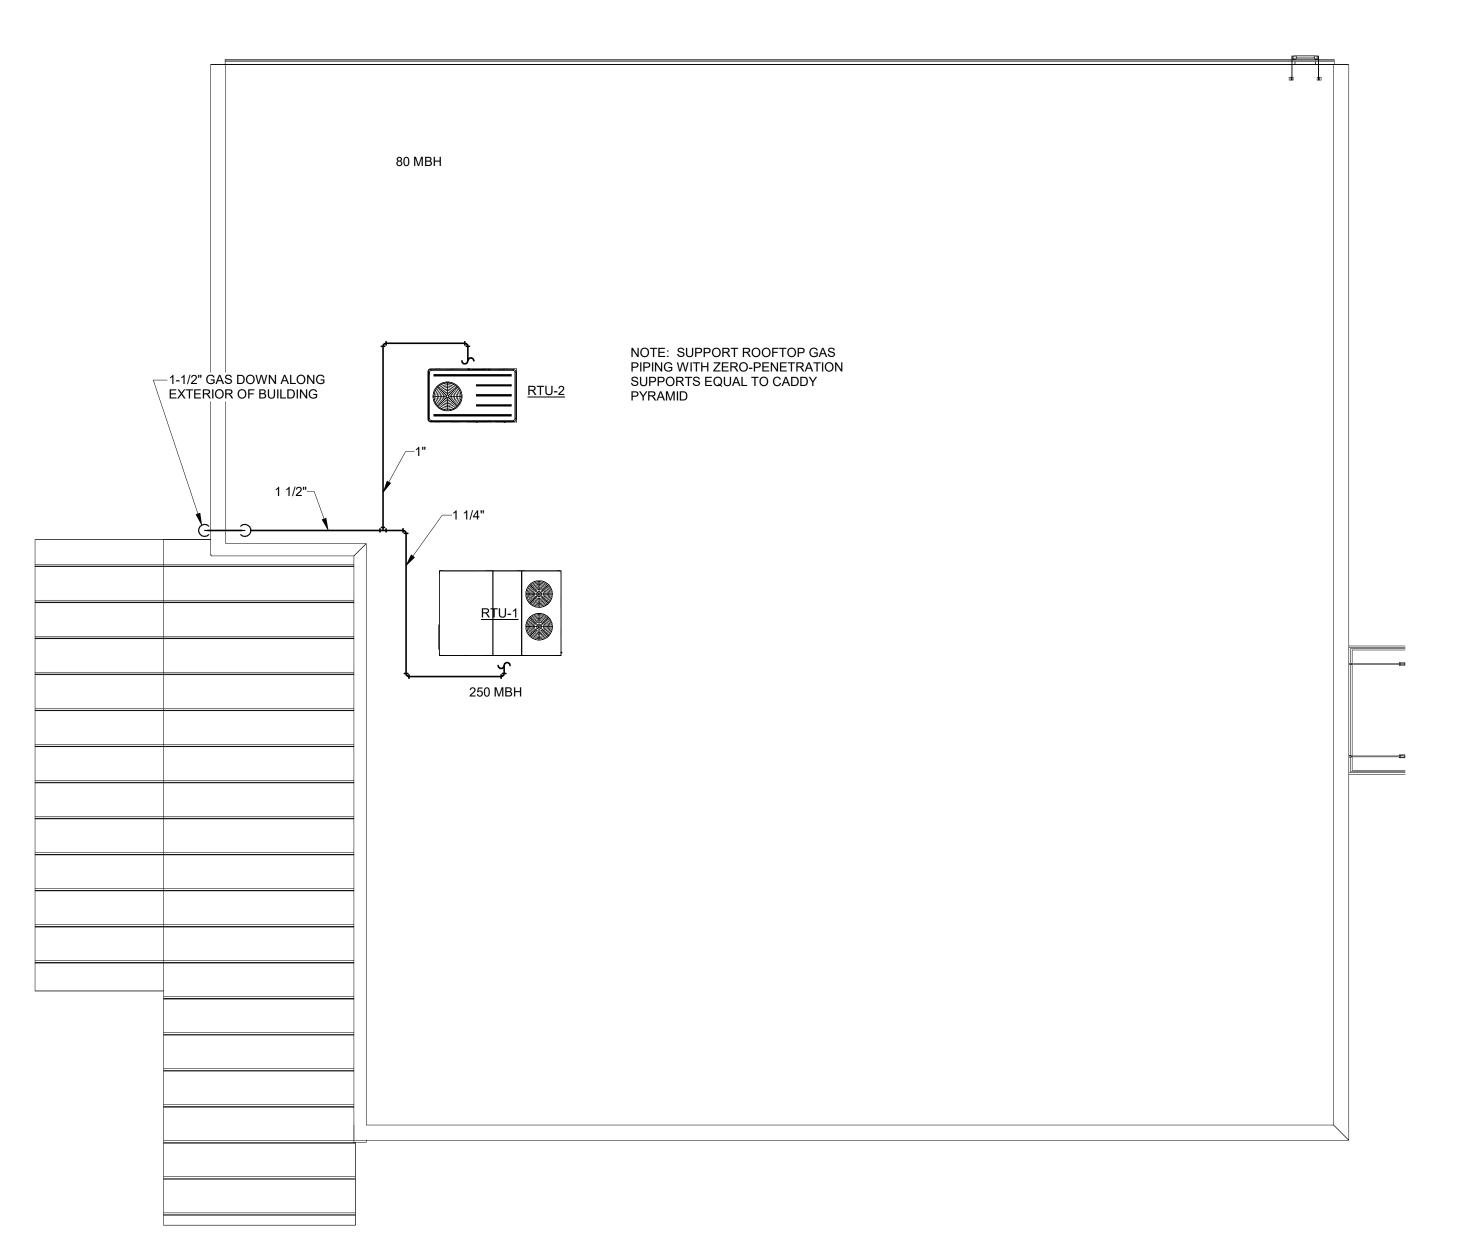


NATURAL GAS FLOOR PLAN

1/8" = 1'-0"

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CENTER RENFIELD FORCE WORK

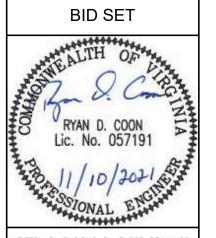

RDC RDC

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PLUMBING

NATURAL GAS PLANS