

PLUMBING SYMBOLS SCHEDULE		
SYMBOL	ABBREV	DESCRIPTION
	CW	COLD WATER
	HW	HOT WATER
	HWR	HOT WATER RECIRCULATION
	TW	TEMPERED WATER
	SAN	SANITARY SEWER
	PSAN	PUMPED SANITARY
	CV	CIRCUIT VENT
	CW&V	COMBINATION WASTE & VENT
	V	SANITARY VENT
	SD	STORM DRAIN, RAINWATER DRAIN
	PSD	PUMPED STORM DRAIN
	OFD	OVERFLOW ROOF DRAINAGE
	TP	TRAP PRIMER PIPING
	G	GAS
	GV	GAS VENT
	A	COMPRESSED AIR
	[XXX"] HW	HOT WATER [XXX"]
	[XXX"] HWR	HOT WATER RETURN [XXX"]
	LA	LABORATORY COMPRESSED AIR
	LV	LABORATORY VACUUM
	RO	REVERSE OSMOSIS WATER
	DI	DISTILLED WATER
	DE	DEIONIZED WATER
	AW	ACID WASTE
	AV	ACID VENT
	GW	GREASE WASTE
	OW	OIL LADEN WASTE
	MA	MEDICAL COMPRESSED AIR
	MV	MEDICAL VACUUM
	OX	OXYGEN
	N	NITROGEN
	NO	NITROUS OXIDE
	WAGD	WASTE ANESTHESIA GAS DISPOSAL
	CO2	CARBON DIOXIDE
	F	FIRE PROTECTION WATER SUPPLY
	SP	AUTOMATIC FIRE SPRINKLER
	ASD	AUTOMATIC FIRE SPRINKLER SYSTEM DRAIN
		ELBOW TURNED UP
		ELBOW TURNED DOWN
		TEE TURNED UP
		TEE TURNED DOWN
		PIPE UNION
		FLEXIBLE PIPE CONNECTION
		PIPE ANCHOR
		PIPE GUIDE
	EXC	EXPANSION COMPENSATOR
		FLOW ARROW
	GA	GATE VALVE
	BF	BUTTERFLY VALVE
	CK	CHECK VALVE
	CBL	CALIBRATED BALANCING VALVE
	TCBV	THERMOSTATICALLY CONTROLLED BALANCING VALVE
	BA	BALL VALVE
	PL	PLUG VALVE
	R	GAS REGULATOR

PLUMBING SYMBOLS SCHEDULE		
SYMBOL	ABBREV	DESCRIPTION
		GAS COCK
		BACKFLOW PREVENTER
	CO	CLEANOUT FLUSH IN FLOOR
	WCO	WALL CLEANOUT FLUSH IN WALL
	WHA-I	WATER HAMMER ARRESTOR (PDI TYPE)
	PRV	PRESSURE REDUCING VALVE
	PS	PRESSURE SWITCH
	TS	VALVE WITH TAPPER SWITCH
	FS	VALVE WITH FLOW SWITCH
		UPRIGHT FIRE SPRINKLER HEADS
		PENDANT FIRE SPRINKLER HEADS
		SIDEWALL FIRE SPRINKLER HEADS
	FHR	FIRE HOSE RACK
	FHC	FIRE HOSE CABINET (SURFACE MTD.)
	FHC	FIRE HOSE CABINET (RECESSED)
	FVC	FIRE VALVE CABINET
	FH	FIRE HYDRANT
	FDC	FIRE DEPARTMENT CONNECTION
		MEDICAL GAS OUTLET
	VS	MEDICAL VACUUM SLIDE BRACKET
		THERMOMETER
		PRESSURE GAGE
		"Y" STRAINER WITH BLOWDOWN VALVE
	WH	WALL HYDRANT
	HB	HOSE BIBB
	FD	FLOOR DRAIN
	FS	FLOOR SINK
	RD	ROOF DRAIN
	OFD	OVERFLOW ROOF DRAIN, EMERGENCY ROOF DRAIN
	OFDN	OVERFLOW DRAIN NOZZLE
		CIRCULATOR
	AP	ACCESS PANEL
	AD	ACCESS DOOR
		DISTANCE FROM FLOOR TO BOTTOM OF OBJECT
		CONNECT TO EXISTING
		POINT OF DEMOLITION
	TXFR	AUTOMATIC FIXTURE TRANSFORMER
RISER TYPE  RISER NUMBER		
REFERENCE NUMBER  SHEET CROSS REFERENCE		
SECTION REFERENCE LETTER  DIRECTION OF VIEW SHEET CROSS REFERENCE		

PLUMBING FIXTURE SCHEDULE VOL 1						
DESIG	DESCRIPTION	OW	HW	TW	SAN	VENT
L-1"	LAVATORY: ADA, OVAL UNDERMOUNT, MANUAL FAUCET.	1/2"	1/2"	3/8"	1-1/4"	1-1/4"
SK-1"	SINK: ADA, STAINLESS STEEL, DROP-IN.	1/2"	1/2"	3/8"	1-1/2"	1-1/2"
WC-1	WATER CLOSET: ADA, MANUAL FLUSH VALVE, FLOOR SET.	1"	-	-	4"	2"

\* WITH TMV-1

PLUMBING EQUIPMENT SCHEDULE	
SYMBOL	DESCRIPTION
TMV-1	THERMOSTATIC MIXING VALVE: 1.0 GPM @ 15 PSI PRESSURE DROP ACROSS VALVE (FLOW RANGE 0.25-2.25 GPM), SET OUTLET TEMPERATURE @ 110° F

GENERAL NOTES (APPLY TO ALL DRAWINGS):

- COMPLY WITH LOCAL, STATE, AND NATIONAL CODES AND REGULATIONS.
- PLAN DOCUMENTS ARE SCHEMATIC TO CONVEY THE DESIGN INTENT. DO NOT SCALE DRAWINGS FOR EXACT PLACEMENT OF EQUIPMENT AND DISTRIBUTION SYSTEMS.
- COORDINATION BETWEEN DISCIPLINES IS THE RESPONSIBILITY OF THE INSTALLING CONTRACTOR AND/OR CONSTRUCTION MANAGER PRIOR TO INSTALLATION.
- THE DRAWINGS AND SPECIFICATIONS ARE COMPLEMENTARY. IN A CASE OF A CONFLICT BETWEEN THE DRAWINGS AND SPECIFICATIONS, REQUEST A DOCUMENTED INTERPRETATION FROM THE ARCHITECT / ENGINEER.
- INSTALL EQUIPMENT PER MANUFACTURER'S INSTALLATION INSTRUCTIONS AND INSURANCE UNDERWRITER REQUIREMENTS.
- THE LINE-TYPE AND SYMBOLS LEGENDS SHOW ITEMS TYPICALLY INCLUDED WITH THE SPECIFIED SYSTEMS. NOT ALL SYMBOLS AND/OR LINE TYPES ARE UTILIZED.
- INCLUDE DETAILS IN THE SCOPE OF WORK FOR EVERY SITUATION TO WHICH THAT DETAIL APPLIES EXCEPT WHERE A SPECIFIC DETAIL REFERENCE IS DESIGNATED TO INDICATE OTHERWISE.
- EXISTING PLUMBING EQUIPMENT, PIPING, AND FIXTURES SHALL REMAIN UNLESS NOTED OTHERWISE.
- SCHEDULE SYSTEM MODIFICATIONS TO MINIMIZE DISRUPTIONS TO EXISTING BUILDING SERVICES. COORDINATE SHUTDOWN REQUESTS PER SPECIFICATIONS AND OWNER REQUIREMENTS.
- LOCATE PIPING AS HIGH AS POSSIBLE, UNLESS NOTED OTHERWISE.
- SEAL PENETRATIONS THROUGH FIRE AND/OR SMOKE BARRIERS WITH AN APPROVED SYSTEM TO MAINTAIN THE INTEGRITY OF THE BARRIER AND SHALL BE MARKED APPROPRIATELY IN ACCORDANCE WITH SPECIFICATIONS.
- INSTALL EXTERIOR FUEL GAS REGULATORS AND METERS AT LEAST 10 FT FROM DOORS, OPERABLE WINDOWS, FRESH AIR OPENINGS, ETC.
- COORDINATE ROOF PENETRATIONS WITH THE ROOFING CONTRACTOR OR ROOF WARRANTY UNDERWRITER TO MAINTAIN ROOFING SYSTEM INTEGRITY.
- MINIMUM PLUMBING PIPING SIZE SHALL BE 1/2" UNLESS NOTED OTHERWISE.
- INSTALL FLEXIBLE CONNECTIONS BETWEEN ALL MOTORIZED EQUIPMENT AND THE CONNECTED SYSTEM. REFER TO SPECIFICATIONS FOR CONNECTION TYPE AND APPLICATION.
- PROVIDE ALL FUEL GAS PIPING WITH A SHUT OFF VALVE, UNION, AND DRIP LEG AT EACH CONNECTION TO GAS FIRE EQUIPMENT.
- SANITARY PIPING UNDERGROUND AND BENEATH SLAB ON GRADE SHALL BE NO LESS THAN 2" IN DIAMETER.
- COORDINATE INSPECTION AND TESTING REQUIREMENTS OF PIPING ENCLOSED IN CMU WALLS WITH AHJ PRIOR TO CONSTRUCTION. DURING CONSTRUCTION, DO NOT ENCLOSE, COVER, OR PUT PIPING INTO OPERATION UNTIL IT HAS BEEN INSPECTED AND APPROVED BY AUTHORITIES HAVING JURISDICTION.


PLUMBING LINETYPE KEY

(APPLIES TO ALL PLUMBING SERVICES OR SYMBOLS)

SYMBOL	DESCRIPTION
	HEAVY LINETYPE INDICATES PIPING AND EQUIPMENT TO BE FURNISHED UNDER THIS PROJECT
	THIN LINETYPE INDICATES PIPING AND EQUIPMENT THAT ARE EXISTING TO REMAIN, UNLESS NOTED OTHERWISE
	DASHED LINETYPE INDICATES PIPING AND EQUIPMENT THAT ARE EXISTING TO BE REMOVED, UNLESS NOTED OTHERWISE

PLUMBING ABBREVIATIONS

AB CL ABOVE CEILING	HC HEATING/WH/AC CONTRACTOR
AT ST AT STRUCTURE	HP HORSEPOWER
BL GD BELOW GRADE	KW KILOWATT
APF ABOVE FINISHED FLOOR	MC MECHANICAL CONTRACTOR
AFG ABOVE FINISHED GRADE	PC PLUMBING CONTRACTOR
BJ BETWEEN JOIST	PSIG POUNDS PER SQUARE INCH GAGE
CFM CUBIC FEET PER MINUTE	RPM REVOLUTIONS PER MINUTE
CIP CAST IRON PIPE	S & WS SOIL & WASTE STACK
Da DIAMETER	SV STACK VENT
EC ELECTRICAL CONTRACTOR	TJ THRU JOIST
ECH EXTENDED COVERAGE HEAD	TR THROUGH ROOF
EX EXISTING	UN FL UNDER FLOOR
FPM FEET PER MINUTE	US S UNDERSIDE STEEL
FT HD FEET OF HEAD	UNO UNLESS NOTED OTHERWISE
GC GENERAL CONTRACTOR	VTR VENT THRU ROOF
GPM GALLONS PER MINUTE	WS WASTE STACK

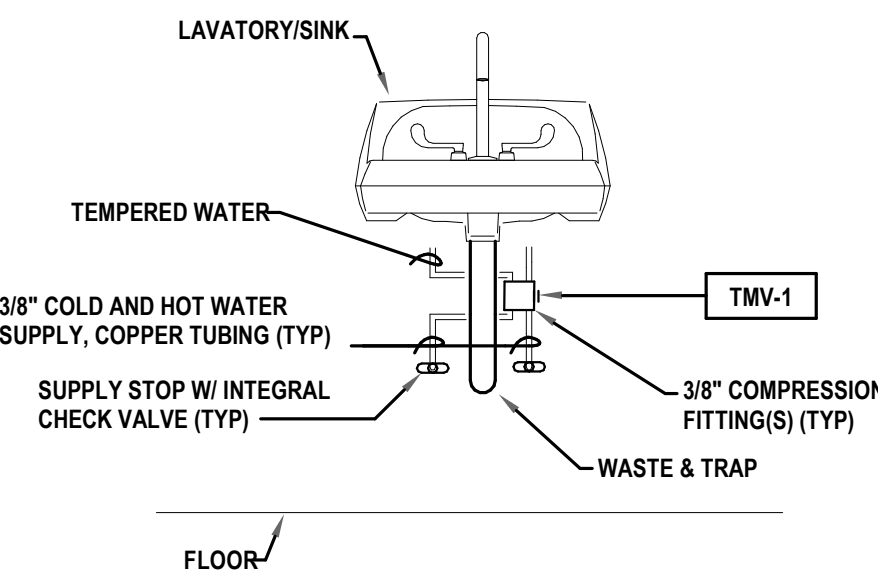

DETAIL 1  
NO SCALE  
THERMOSTATIC MIXING VALVE AT  
LAVATORY/SINK

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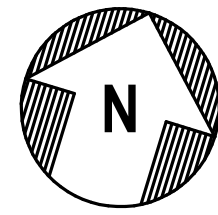
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NOTES -  
PLUMBING**



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### FIRST FLOOR PLAN — DOMESTIC WATER

SCALE: 1/8" = 1'-0"



### LOWER LEVEL — DOMESTIC WATER


SCALE: 1/8" = 1'-0"
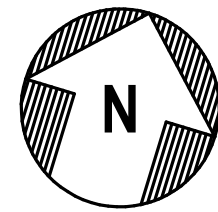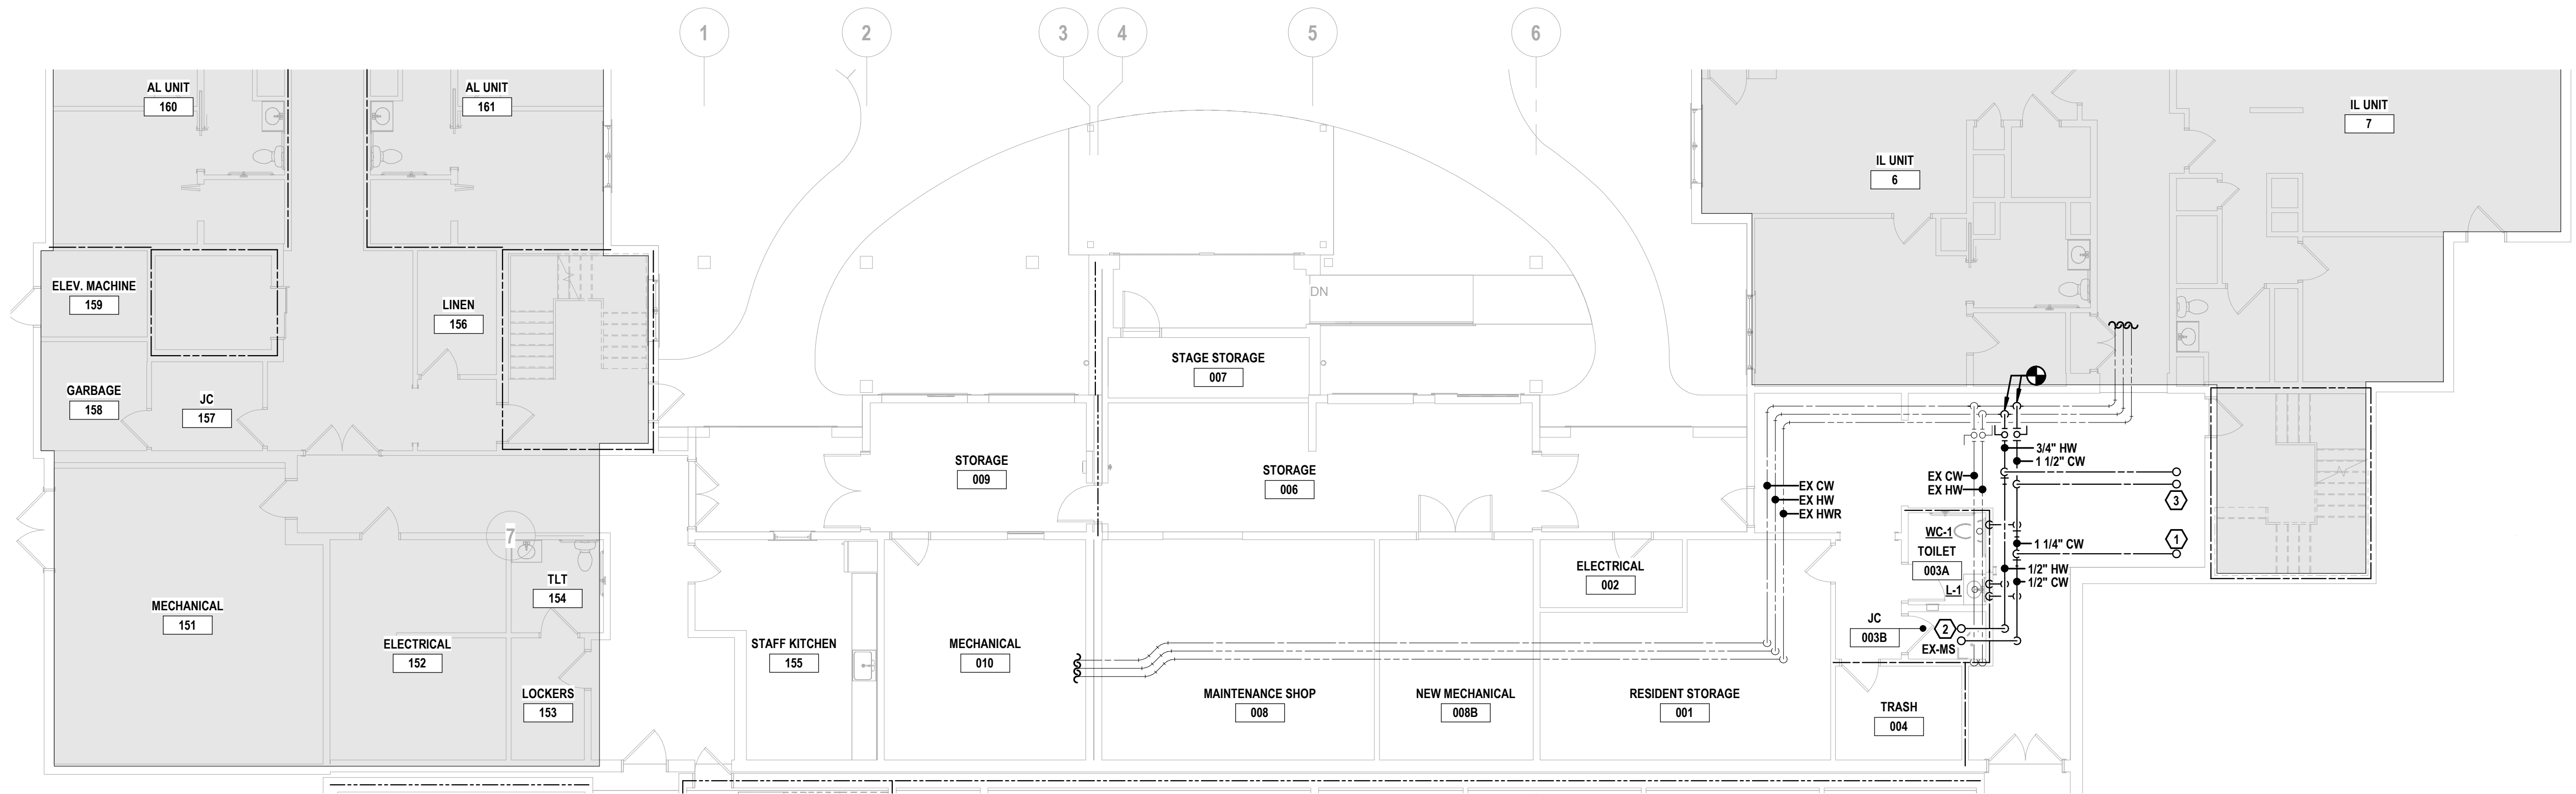
### NOTES

- 1"DCW PIPING TO SERVE WATER CLOSET ABOVE.
- 1/2"DCW & 1/2"DHW PIPING TO SERVE SINK ABOVE.
- 1/2"DCW & 1/2"DHW PIPING TO SERVE LAVATORY ABOVE.
- 1/2"DCW & 1/2"DHW PIPING TO LAVATORY SERVED FROM BELOW.
- 1"DCW PIPING TO WATER CLOSET SERVED FROM BELOW.
- 1/2"DCW & 1/2"DHW PIPING TO SINK SERVED FROM BELOW.

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PLANS -  
DOMESTIC  
WATER**

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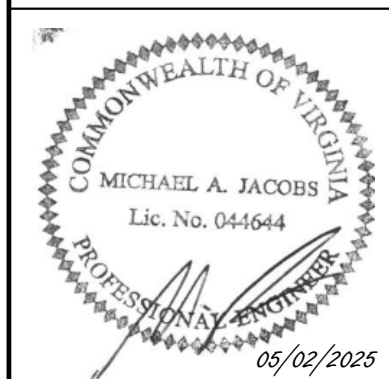
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WALL FIRE RATINGS KEY	
1-HOUR RATED FIRE PARTITION	-----
1-HOUR RATED FIRE BARRIER / SHAFT WALL	-----
2-HOUR RATED FIRE BARRIER / SHAFT WALL	-----
2-HOUR FIRE WALL	-----
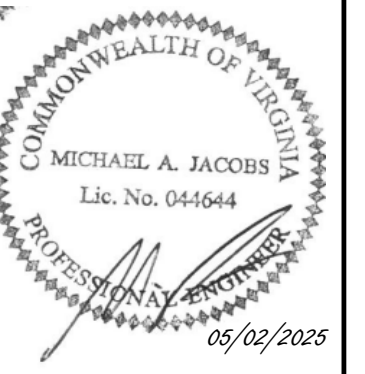
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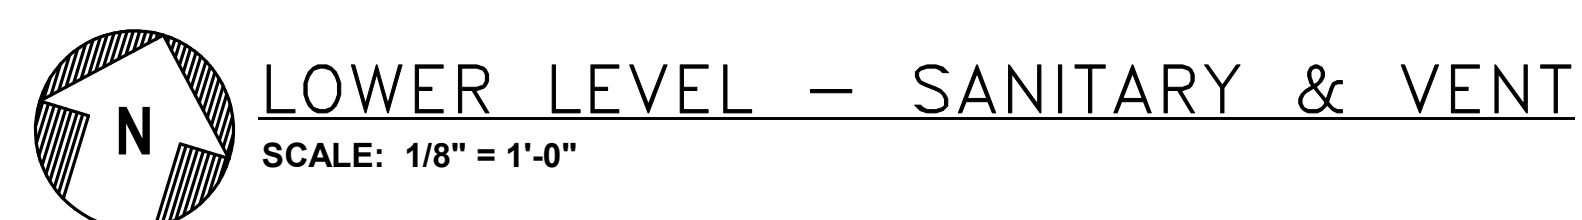
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
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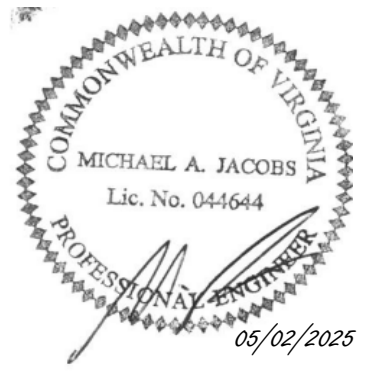
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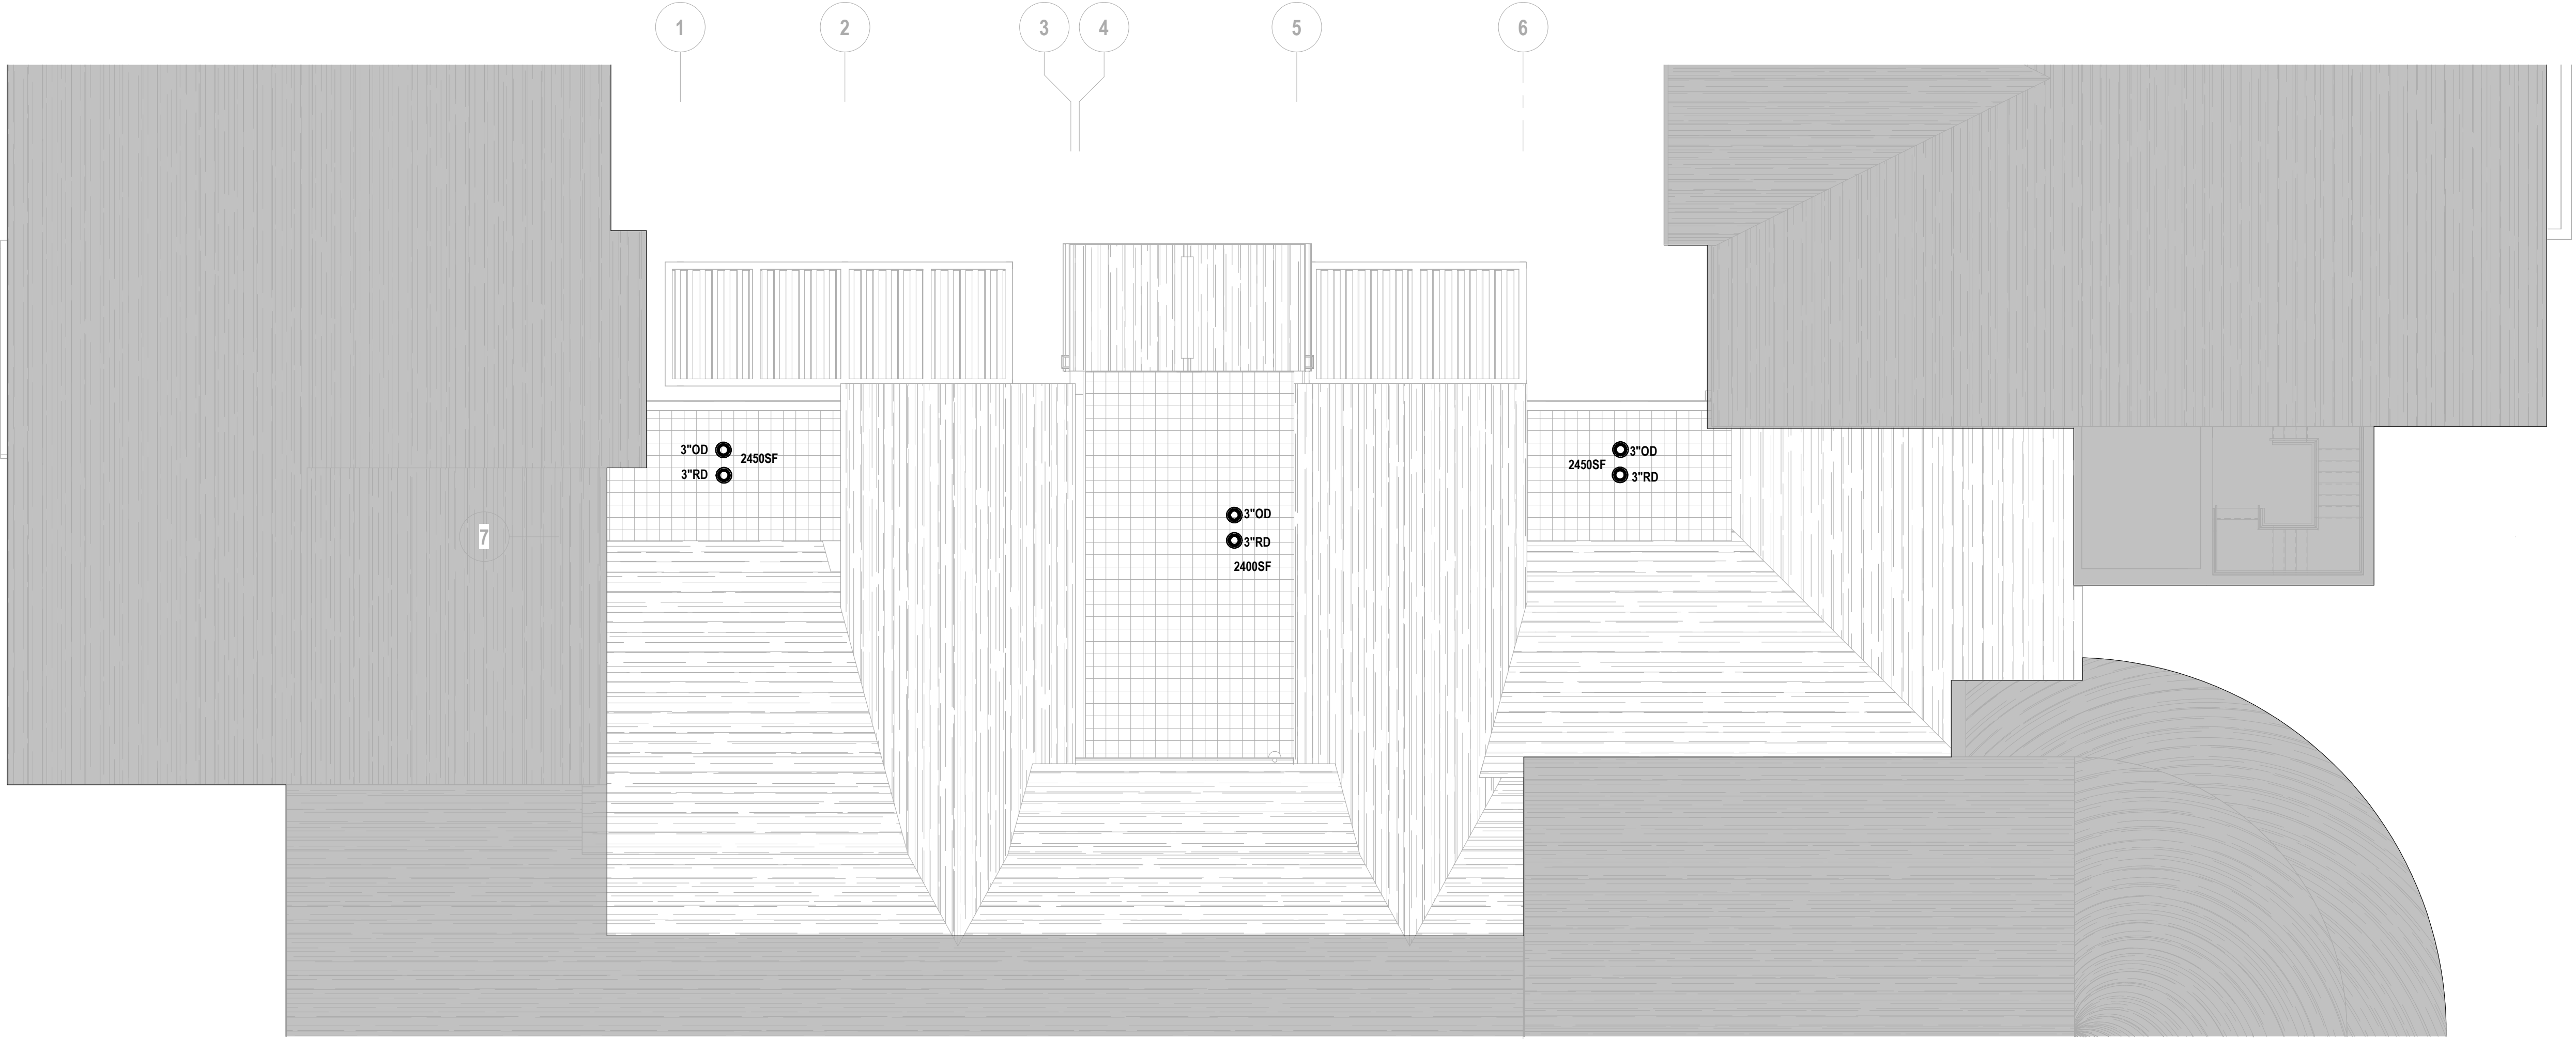
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**ROOF PLAN -  
STORM**

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 **SECOND FLOOR PLAN – STORM**  
SCALE: 1/8" = 1'-0"

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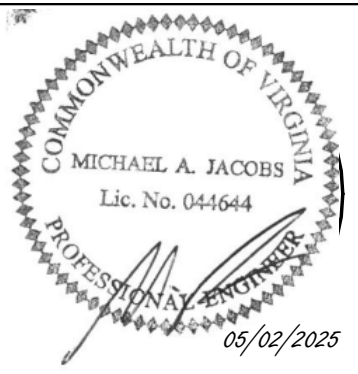
  
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DRAWING TITLE:  
**LOWER AND  
FIRST FLOOR  
PLANS -  
DEMOLITION -  
HVAC**

SCALE: AS NOTED

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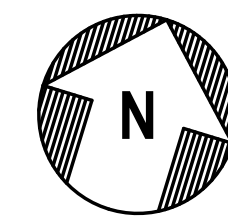
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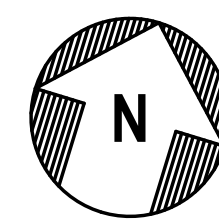
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FIRST FLOOR PLAN – DEMOLITION – HVAC  
SCALE: 1/8" = 1'-0" 17



LOWER LEVEL - DEMOLITION - HVAC

WALL FIRE RATINGS KEY	
1-HOUR RATED FIRE PARTITION	_____
1-HOUR RATED FIRE BARRIER / SHAFT WALL	_____
2-HOUR RATED FIRE BARRIER / SHAFT WALL	_____
2-HOUR FIRE WALL	_____



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DRAWING TITLE:  
**LOWER AND  
FIRST FLOOR  
PLANS -  
DUCTWORK**

SCALE: AS NOTED

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- WATER SOURCE HEAT PUMP TO REMAIN.
- CONNECT OUTSIDE AIR DUCTWORK TO EXISTING DUCTWORK. EXTEND TO LOUVER HIGH ON WALL OF STORAGE 009.
- RELOCATE VERTICAL WATER SOURCE HEAT PUMP AND PIPING IN EXISTING MECHANICAL CHASE. RELOCATE SUPPLY AND RETURN GRILLES TO BE STACKED ON WALL. RETURN GRILLE IS INTEGRATED WITH FRONT ACCESS PANEL. SUPPLY AND RETURN DUCTS ATTACHED TO UNIT TO REMAIN. THERMOSTAT SHALL BE RELOCATED. REFER TO PIPING PLANS.
- INSTALL EXHAUST DUCT TO WALL CAP WITH INSECT SCREEN. BACKDRAFT DAMPER AT FAN.
- PROVIDE BACKDRAFT DAMPER IN RELIEF AIR DUCTWORK. AIR TO TRAVEL FROM MECHANICAL ROOM TO EXTERIOR.
- RETURN DUCT UP FROM BELOW. PROVIDE RETURN GRILLES STACKED IN HIGH AND LOW COMBINATION. ONE WITHIN 12" OF FLOOR. ONE WITHIN 12" OF CEILING. TURN BLADES DOWN TOWARDS FLOOR AND UP TOWARDS CEILING.
- LINEAR GRILLE TO BE INSTALLED WITH PLENUM ABOVE CEILING. AIRFLOW TO BE HORIZONTAL ALONG CEILING.
- SUPPLY GRILLE INSTALLED ON BULKHEAD, AS LOW AS POSSIBLE. BLADE SPREAD TO BE 45 DEGREES.
- INSTALL FIRE DAMPER AT DUCT PENETRATION THROUGH FIRE WALL. CONNECT TO EXISTING DUCTWORK ABOVE CEILING. COORDINATE WITH ARCHITECT TO PROVIDE CEILING ACCESS PANEL FOR FIRE DAMPER.
- INSTALL FIRE DAMPER IN DUCT THROUGH FIREWALL.
- INSTALL FIRE DAMPER IN DUCT AT RATED FLOOR/CEILING PENETRATION. DUCT CONTINUES THROUGH VERTICAL CHASE AT FLOOR ABOVE.
- INSTALL DUCT TIGHT TO BOTTOM OF CEILING.
- INSTALL TRANSFER GRILLE HIGH ON WALL ABOVE DOOR.
- INSTALL STACKED AIR HANDLER ON 6" THICK EQUIPMENT MOUNTING PAD. MINIMUM 4" LARGER ON EACH SIDE OF UNIT.
- 42X16 OUTSIDE AIR DUCT LOW FROM AIR HANDLER. TO BE ROUTED NEAR FLOOR. INSTALL VERTICAL RISER AFTER CLEARING RETURN AIR ABOVE. TRANSITION DUCT SIZE PRIOR TO ELBOW TO HORIZONTAL.
- INSTALL RETURN AIR DUCT STACKED ABOVE OUTSIDE AIR DUCT.
- INSTALL RETURN AIR DUCT JUST BELOW OVERHEAD PIPING IN AREA.
- INSTALL RETURN GRILLE LOW ON WALL. TURN BLADES DOWN TOWARDS FLOOR.
- DUCTWORK SHALL BE INSTALLED ON FIRST FLOOR ABOVE HARD GYPSEUM CEILING AND BELOW RATED LAYER AT ATTIC TRUSSES.
- EXISTING GRILLES SHALL BE RE-BALANCED TO SUPPLY CFMS AS INDICATED.
- RETURN TAP TO BE ON TOP OF DUCT.
- SUPPLY DUCT UP FROM TOP DISCHARGE AT AIR HANDLER. ROUTE TOWARDS WALL IN VERTICAL. RISE AND ELBOW OVER TO LINE UP WITH BOTTOM OF CHASE. TRANSITION DUCT SIZE IN VERTICAL. RISER.
- INSTALL DUCTLESS AIR HANDLER HIGH ON WALL. BOTTOM ON UNIT TO BE 6" ABOVE DOOR.
- INSTALL CONDENSER AT GRADE ON EQUIPMENT PAD.
- INSTALL OUTSIDE AIR LOUVER HIGH ON WALL. LOUVER TO BE 40" WIDE AND 24" HIGH. GREENHECK ESD-635. COORDINATE FINISH WITH ARCHITECT.
- INSTALL OUTSIDE AIR LOUVER HIGH ON WALL. LOUVER TO BE 32" WIDE AND 32" HIGH. GREENHECK ESD-635. COORDINATE FINISH WITH ARCHITECT.
- INSTALL OUTSIDE AIR LOUVER HIGH ON WALL. LOUVER TO BE 48" WIDE AND 26" HIGH. GREENHECK ESD-635. COORDINATE FINISH WITH ARCHITECT.
- FLEX DUCT SHALL BE SAME SIZE AS DIFFUSER NECK. UNLESS NOTED OTHERWISE. FLEX DUCT TO LINEAR DIFFUSERS SHALL BE 8" DIAMETER UNLESS NOTED OTHERWISE.
- CLEAN ALL EXISTING DUCTWORK TO REMAIN FOLLOWING DEMOLITION AND PRIOR TO NEW WORK.
- ACCESS PANEL AT CEILING TO BE PROVIDED BY ARCHITECT TO ALLOW SERVICING OF VAV-3.
- INSTALL VOLUME DAMPER IN EXISTING DUCTWORK. VOLUME DAMPER TO INCLUDE CONTROL CABLE FOR REMOTE BALANCING. INSTALL CONTROLLER ON WALL OR ON CEILING WITH COVER. SIMILAR TO OR EQUAL TO 8302ACC2 BY YOUNG REGULATOR.
- FIRE DAMPERS AT SUPPLY AND RETURN GRILLE TO BE ACCESSIBLE THROUGH FRONT OF GRILLES.

WALL FIRE RATINGS KEY	
1-HOUR RATED FIRE PARTITION	_____
1-HOUR RATED FIRE BARRIER / SHAFT WALL	_____
2-HOUR RATED FIRE BARRIER / SHAFT WALL	_____
2-HOUR FIRE WALL	_____





NOTES

1. CONNECT CHILLED WATER SUPPLY TO MAIN LINE IN MECHANICAL ROOM. COORDINATE EXACT TIE-IN LOCATION WITH BUILDING OWNER.
2. CONNECT CHILLED WATER RETURN TO MAIN LINE IN MECHANICAL ROOM. COORDINATE EXACT TIE-IN LOCATION WITH BUILDING OWNER.
3. CONNECT HOT WATER SUPPLY TO MAIN LINE IN MECHANICAL ROOM. COORDINATE EXACT TIE-IN LOCATION WITH BUILDING OWNER.
4. CONNECT HOT WATER RETURN TO MAIN LINE IN MECHANICAL ROOM. COORDINATE EXACT TIE-IN LOCATION WITH BUILDING OWNER.
5. INSTALL HOT WATER LINES UP TO ABOVE 1ST FLOOR. UTILIZE EXISTING CHASE ABOVE. COORDINATE LOCATION WITH SUPPLY DUCTWORK.
6. HYDRONIC PIPING DOWN TO COIL CONNECTIONS AT AIR HANDLER.
7. ROUTE NEW HYDRONIC PIPING ABOVE LOWER LEVEL CEILING. COORDINATE EXACT ROUTING WITH BUILDING OWNER.
8. VAV HOT WATER CONNECTIONS TO BE 3/4".
9. ROUTE HYDRONIC PIPING ABOVE CEILING OF STORAGE ROOM. COORDINATE EXACT ROUTING WITH EXISTING CONDITIONS.
10. ROUTE HYDRONIC PIPING ABOVE CEILING OF SERVICE CORRIDOR. COORDINATE EXACT ROUTING WITH EXISTING CONDITIONS.
11. PIPING UP TO FIRST FLOOR. REFERENCE VOLUME II FOR CONTINUATION.
12. CHILLED WATER DOWN TO JUST BELOW HEIGHT OF HOT WATER. ALL HYDRONIC PIPING IN MAINTENANCE SHOP TO BE AS HIGH AS POSSIBLE.
13. HOT WATER PIPING IN CHASE TO SHARE SPACE WITH SUPPLY DUCT.
14. PROVIDE CONDENSER WATER SUPPLY AND RETURN LINES. CONNECT TO EXISTING LINES AT LOCATION INDICATED AND EXTEND TO RELOCATED VERTICAL WSHIP.
15. PUMPED CONDENSATE LINE UP ALONG WALL FROM CP-1 ON FLOOR.
16. CONDENSATE LINE DOWN WALL TO DISCHARGE JUST ABOVE MOP SINK.
17. ROUTE CONDENSATE FROM COOLING COIL LOW THROUGH WALL TO CONDENSATE PUMP CP-1.
18. RELOCATE THERMOSTAT TO LOCATION AS SHOWN.
20. REFRIGERANT LINE FROM CU-1 UP IN WALL AND TO ROUTE OVERHEAD AND TO SSAC-1 ON WALL.
21. CONDENSATE DOWN IN WALL TO TERMINATE LOW ON WALL AT GRADE.
22. PROVIDE NEW CONDENSATE LINE TO CONNECT TO CONDENSATE DRAIN LINE FROM PREVIOUS LOCATION.
23. PRIOR TO NEW WORK, PERFORM PRE-CONSTRUCTION AUDIT TO CONFIRM ALL EXISTING HOT AND CHILLED WATER FLOWS. AT THE COMPLETION OF CONSTRUCTION, CONFIRM NEW FLOWS AND VERIFY EXISTING ARE UNCHANGED.
24. PROVIDE A DRAIN DIRECTED TOWARDS THE FLOOR AT THE NEW PIPING CONNECTION. SHALL CONSIST OF 3/4" SHUT-OFF VALVE WITH HOSE COUPLING.

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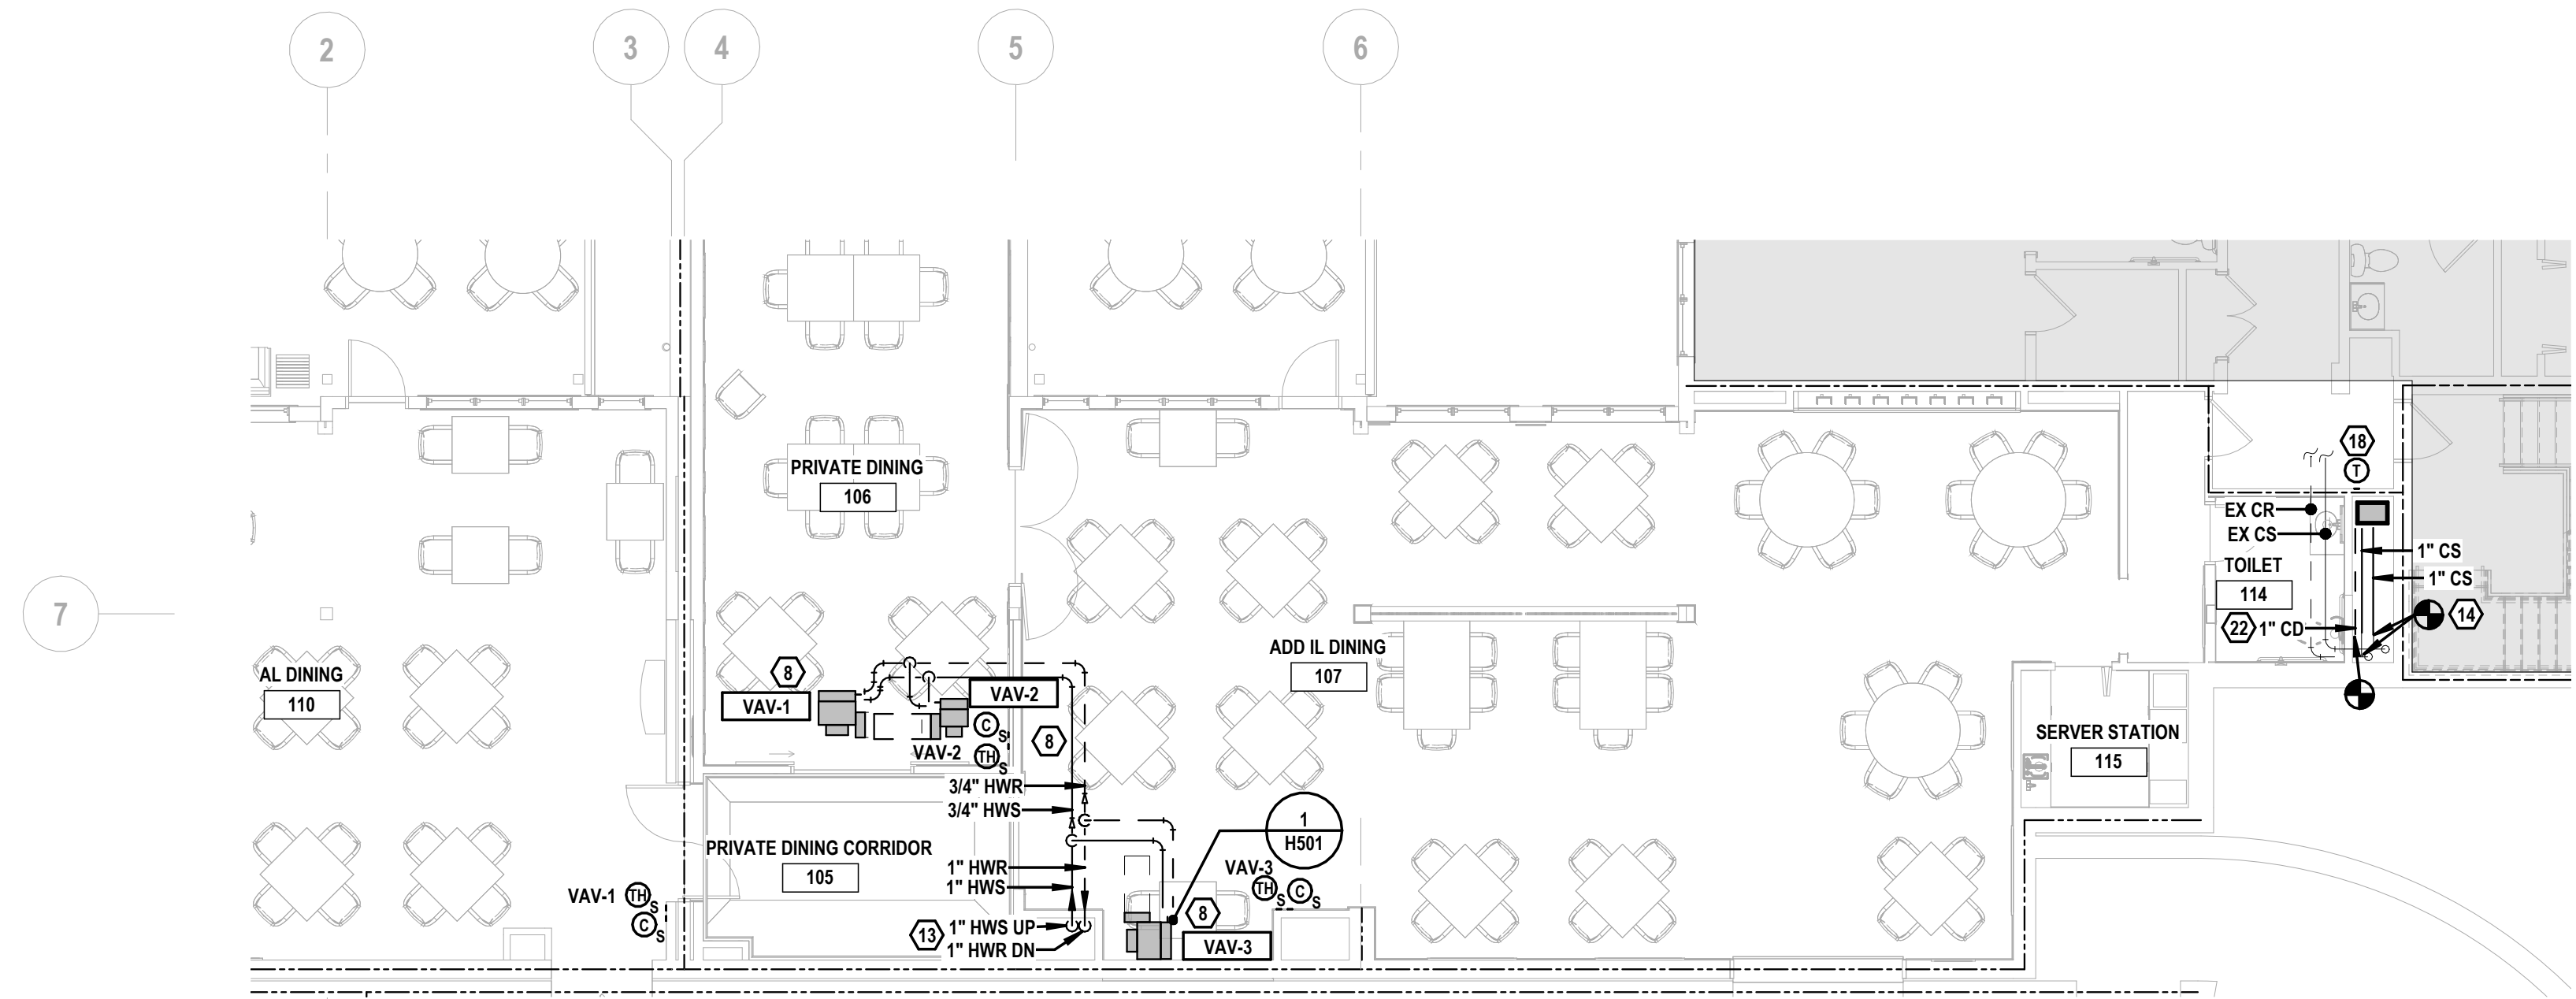
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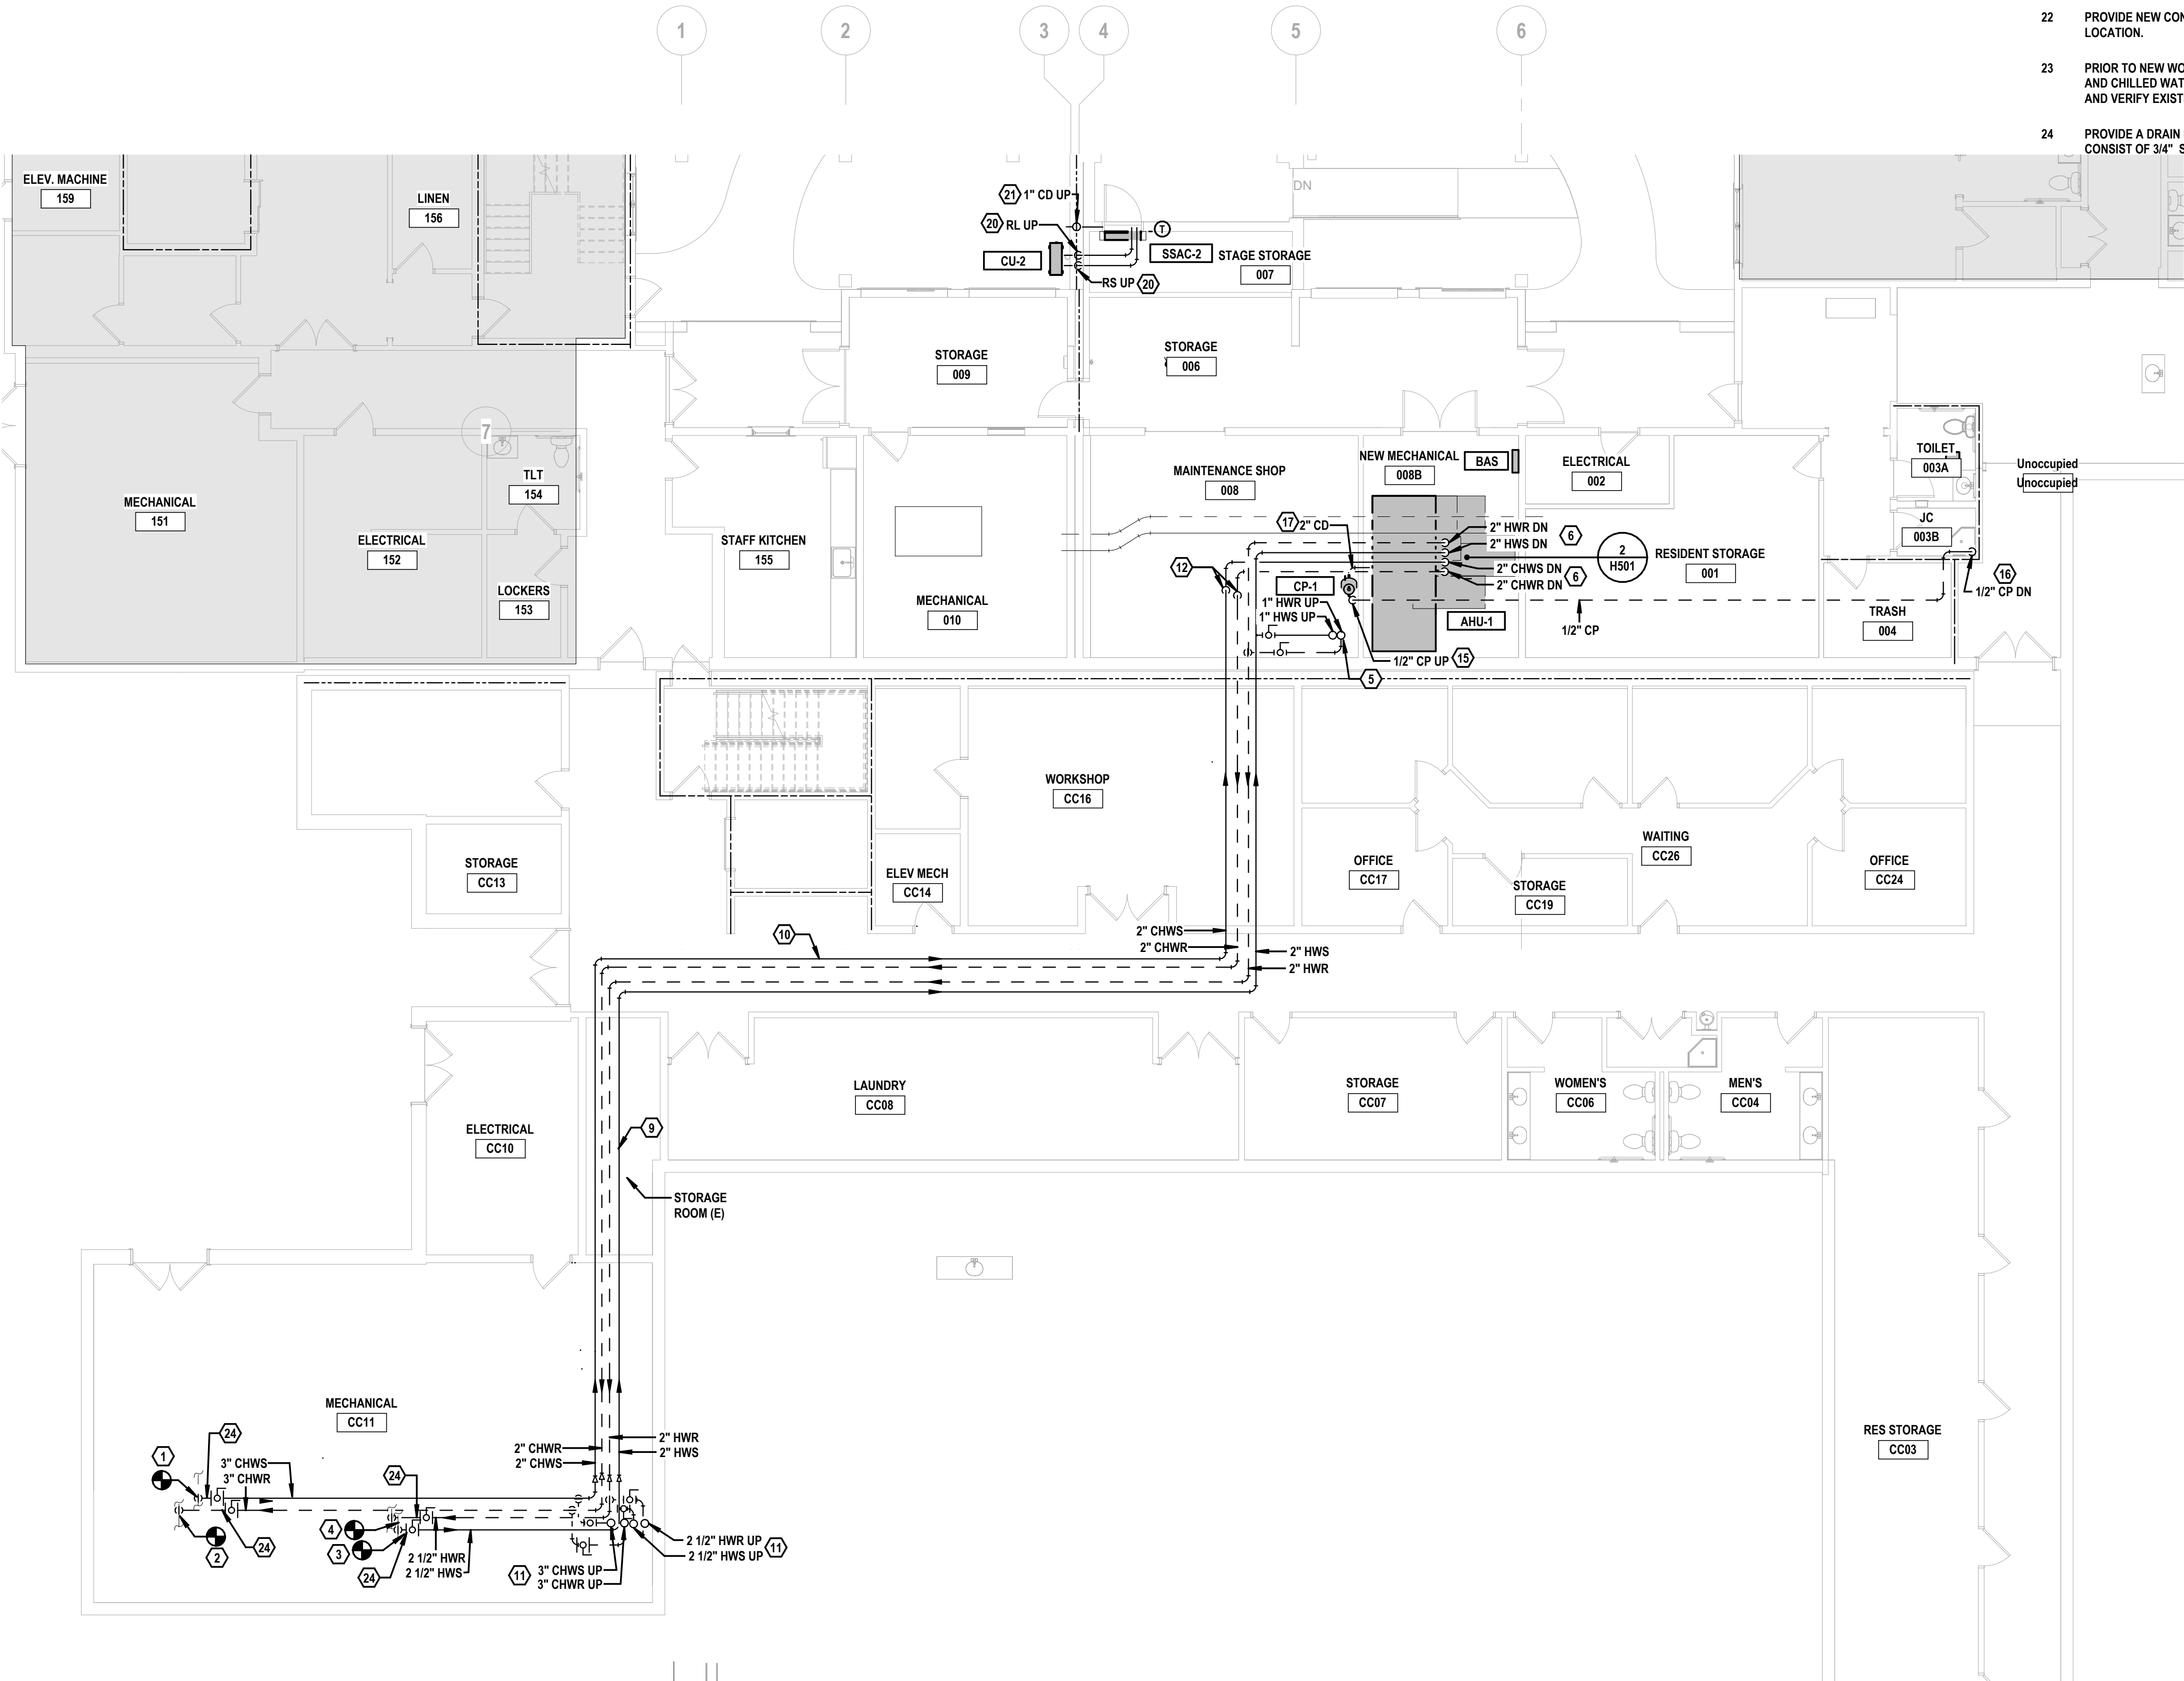
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**LOWER AND  
FIRST FLOOR  
PLANS - PIPING**

SCALE: AS NOTED  
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COORDINATED BY:  
CHECKED BY:  
APPROVED BY:  
  
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VOLUME I  
DRAWING NO:  
**H200**  
COMMISSION NO: **2024109**  
DATE: **2 MAY 2025**



**FIRST FLOOR PLAN — PIPING**  
SCALE: 1/8" = 1'-0"





**LOWER LEVEL — PIPING**  
SCALE: 1/8" = 1'-0"

WALL FIRE RATINGS KEY	
1-HOUR RATED FIRE PARTITION	-----
1-HOUR RATED FIRE BARRIER / SHAFT WALL	=====
2-HOUR RATED FIRE BARRIER / SHAFT WALL	=====
2-HOUR FIRE WALL	=====


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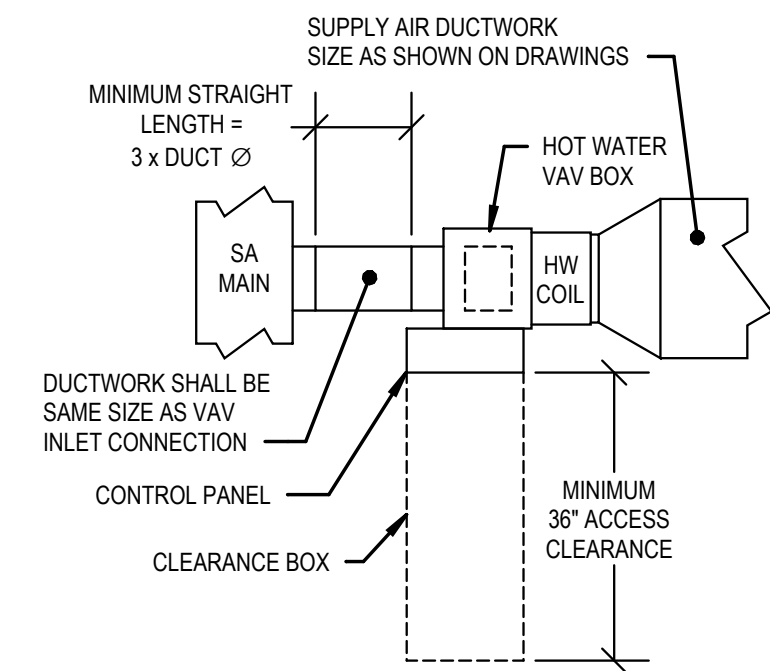


- | POSITION | MODULE   | POSITION | MODULE                                       |
|----------|--|----------|--|
| 1        | EXHAUST FAN WITH FRONT TOP OUTLET (NON-DUCTED) AND INTEGRATED DAMPER | 5        | CHILLED WATER COIL WITH ACCESS               |
| 2        | FILTER/MIXING SECTION W/ OUTSIDE AIR & RETURN DAMPER                 | 6        | SUPPLY FAN (PLENUM)                          |
| 3        | AIR MIXING SECTION WITH RETURN AIR CONNECTION                        | 7        | PRESSURIZED SUPPLY PLENUM WITH TOP DISCHARGE |
| 4        | PREHEAT COIL WITH ACCESS   |          |  |

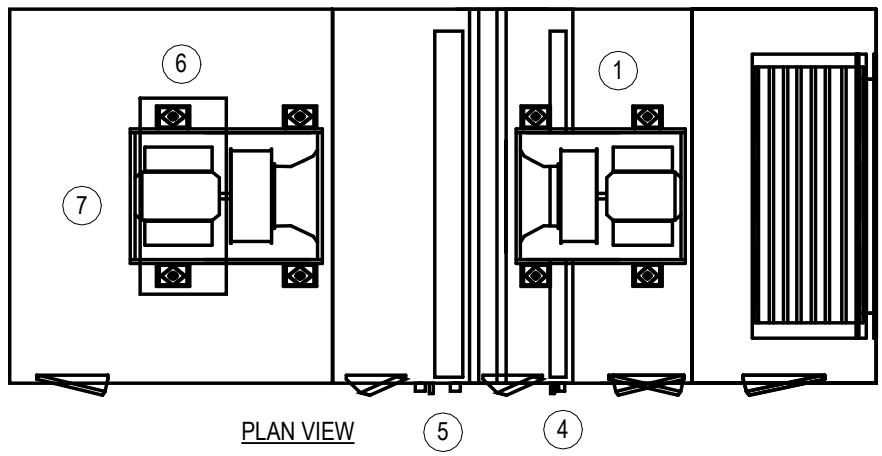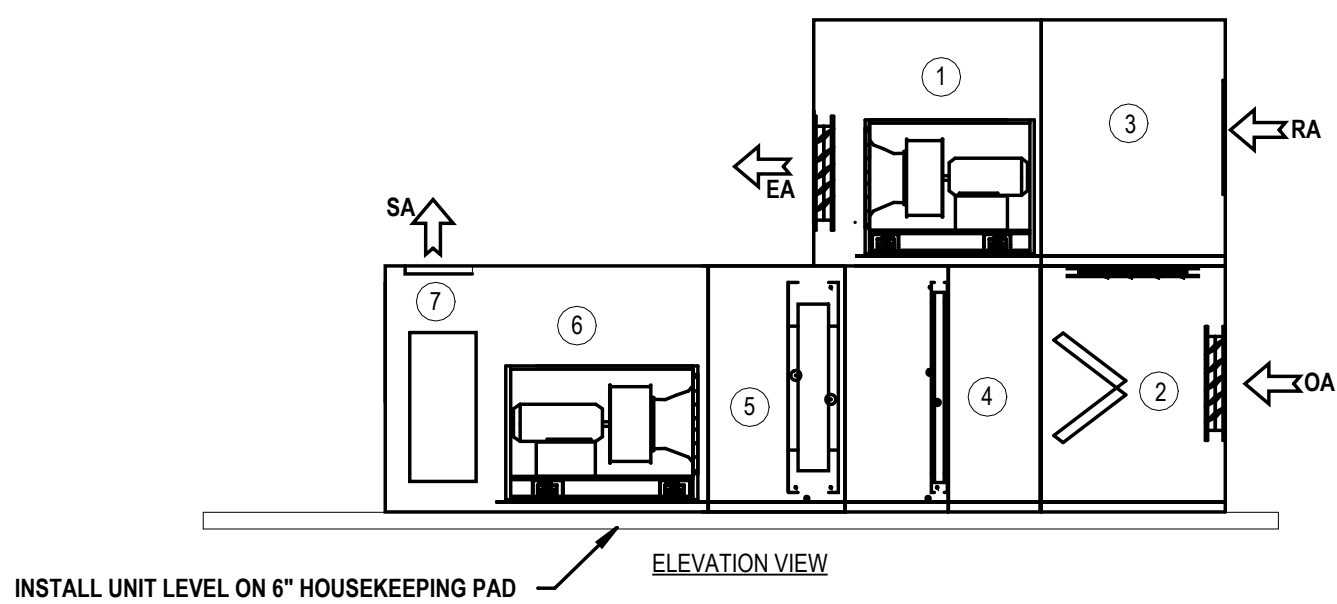
DETAIL 7  
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INDOOR AIR HANDLING UNIT WITH EXHAUST FAN




DETAIL 4  
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FLEXIBLE DUCT TO SQUARE DIFFUSER

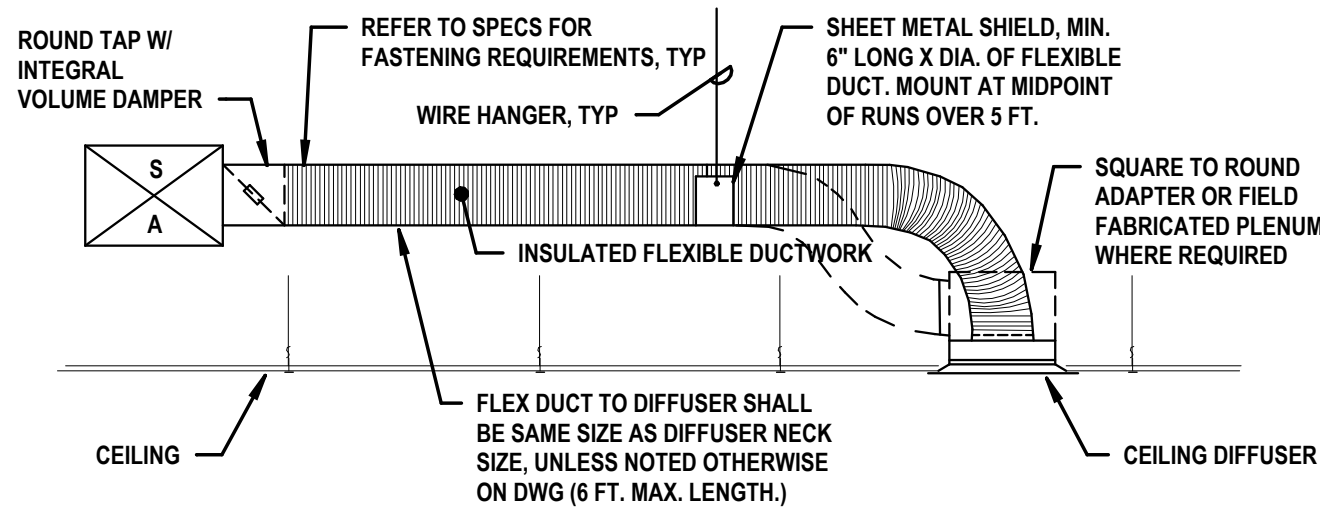


DETAIL 5  
NO SCALE  
HOT WATER VAV BOX DUCTWORK INLET CONNECTIONS

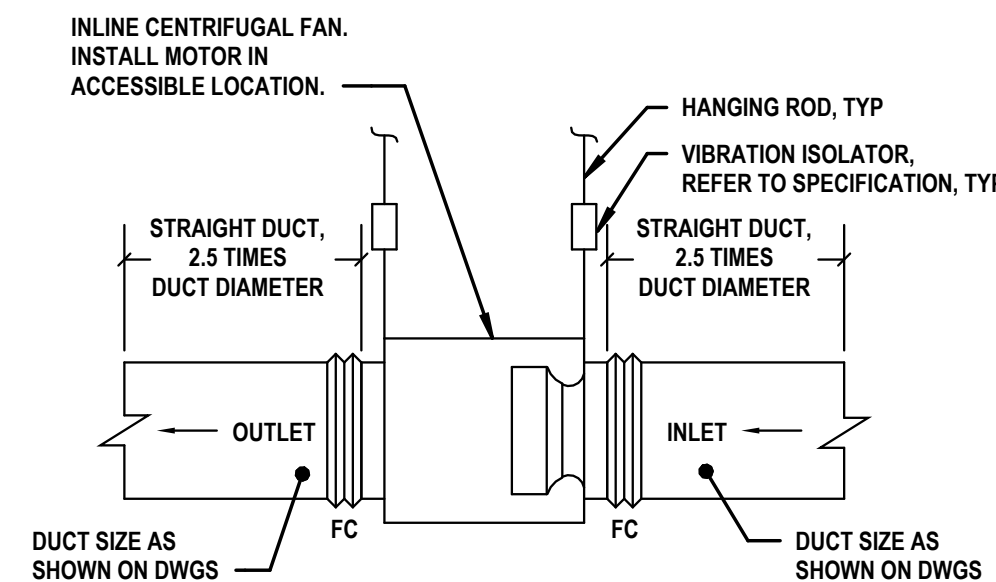


DETAIL 6  
NO SCALE  
INLINE CENTRIFUGAL FAN

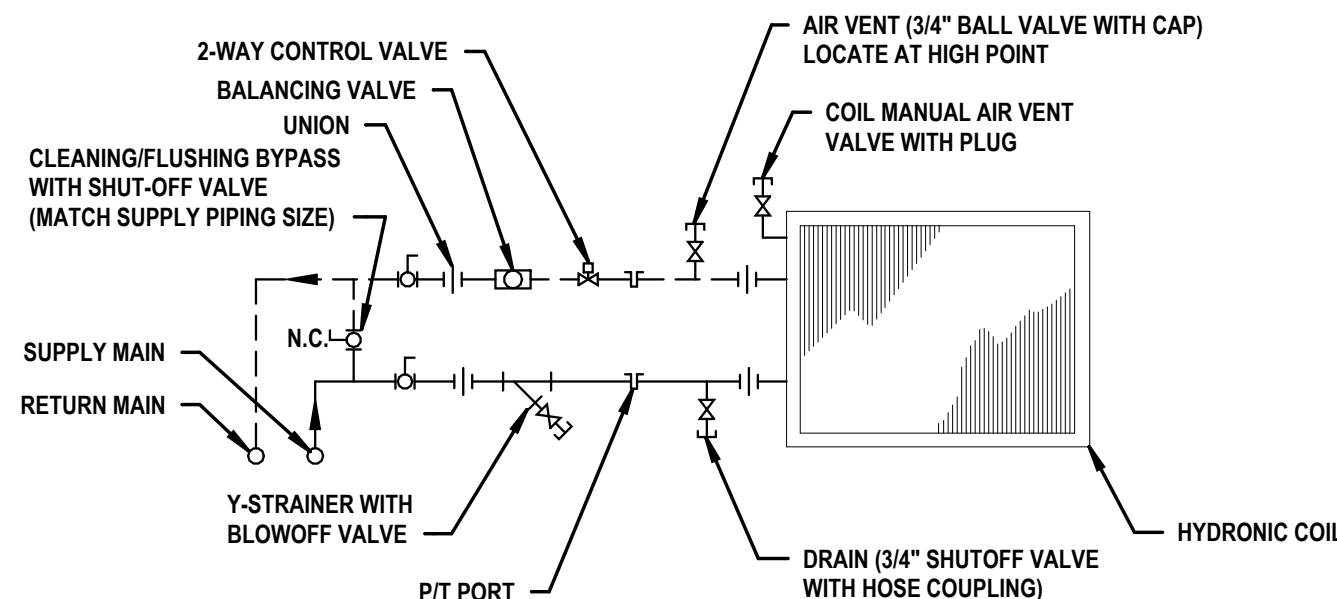

DETAIL 1  
NO SCALE  
COIL CONNECTION, VAV, 2-WAY

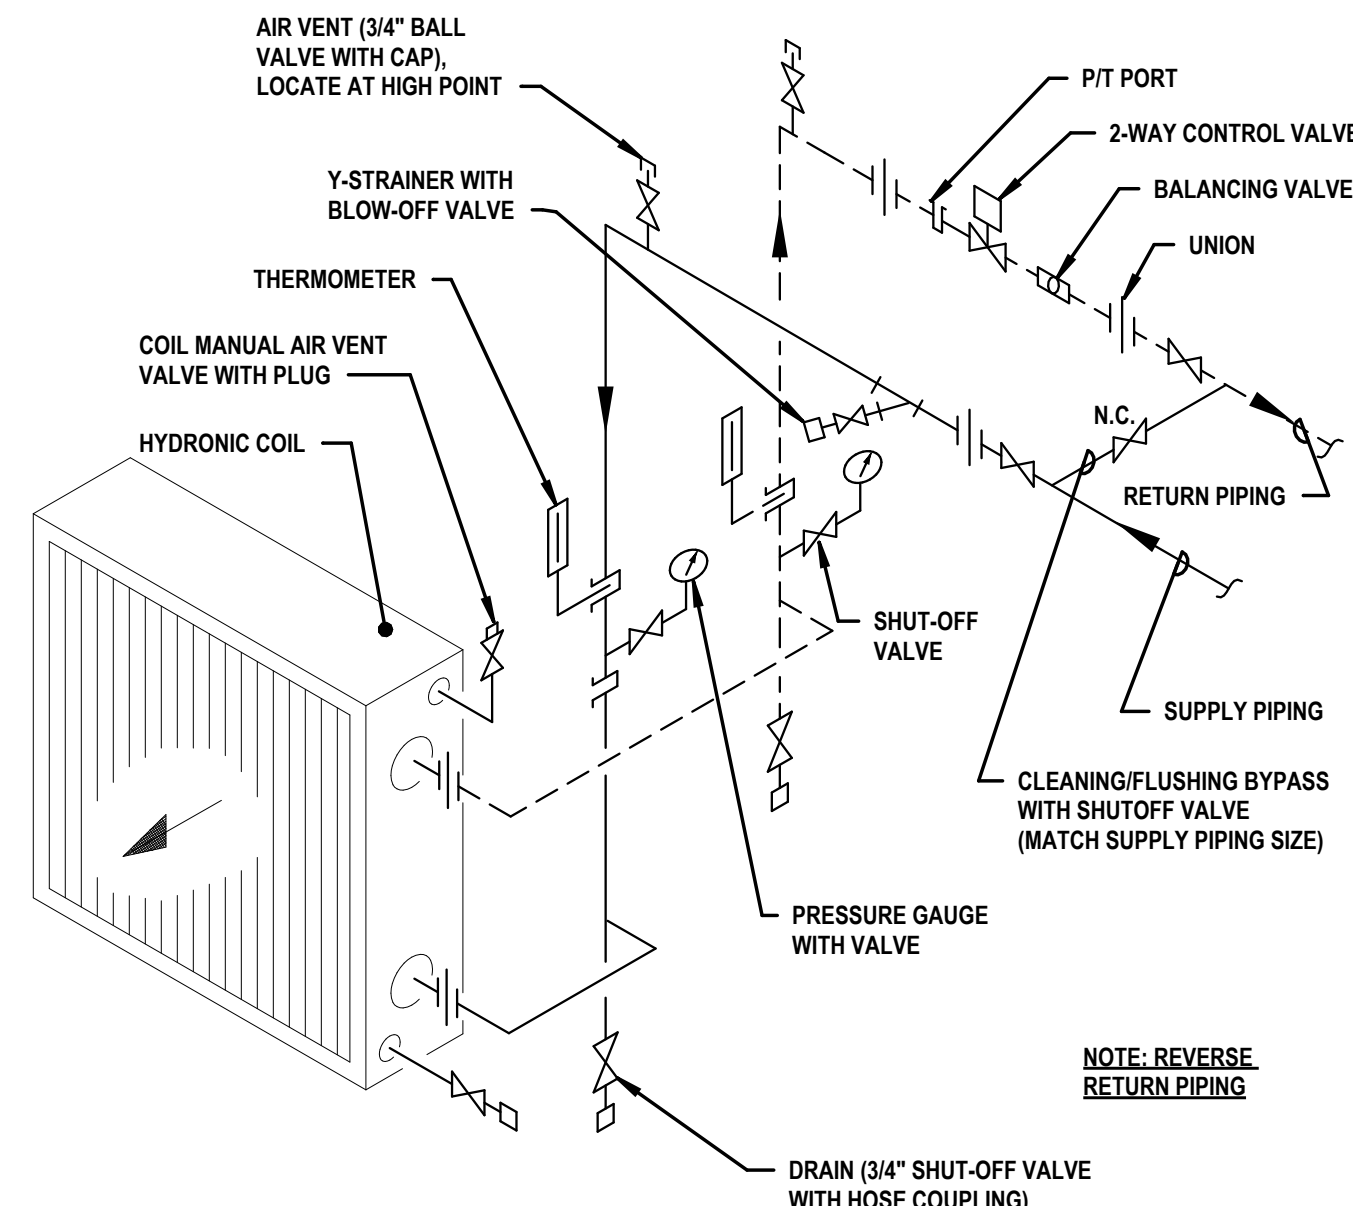


DETAIL 2  
NO SCALE  
COIL CONNECTION, SINGLE, AHU, 2-WAY

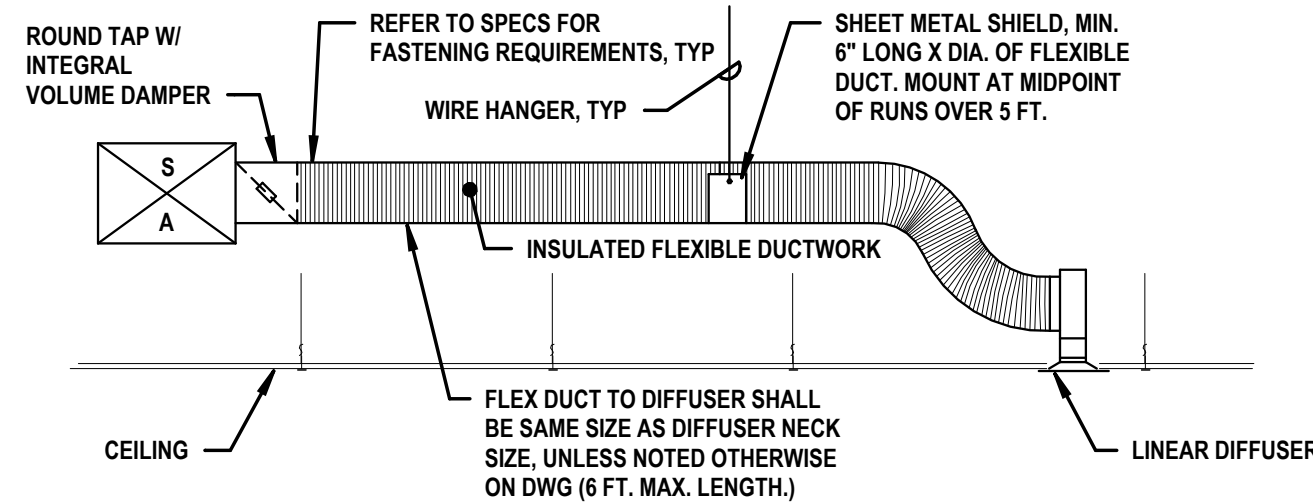

DETAIL 3  
NO SCALE  
FLEXIBLE DUCT TO LINEAR DIFFUSER

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APPROVED BY:

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VOLUME I  
DRAWING NO:  
**H501**  
COMMISSION NO: **2024109**  
DATE: **2 MAY 2025**

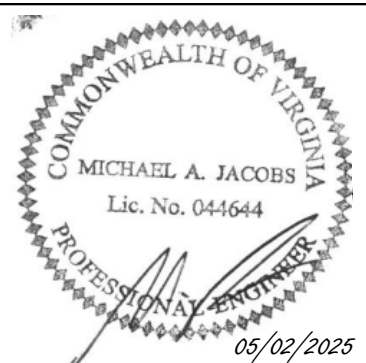

AIR HANDLING UNIT SCHEDULE, EXHAUST FAN, WATER PREHEAT & WATER COOLING																																																								
DESIG	DESCRIPTION AND AREA SERVED	SUPPLY FAN DATA															EXHAUST FAN DATA															COOLING COIL, WATER															PREHEAT COIL, WATER									
		CFM			FAN					ELECTRICAL					TOTAL CFM	FAN					ELECTRICAL					COIL FA (SQ FT)	COIL FV (FPM)	ROWS	FINS PER INCH	MBH					LAT (°F)		EWT (°F)	LWT (°F)	APD (IN WG)	WPD (FT HD)	GPM	COIL FA (SQ FT)	COIL FV (FPM)	ROWS	FINS PER INCH	TUBE VELOCITY (FPS)	MBH	EAT (°F)	LAT (°F)	EWT (°F)	LWT (°F)	APD (IN WG)	WPD (FT HD)	GPM		
		TOT	OA	MIN	ESP (IN WG)	RPM	TYPE	DIA.	DRIVE	HP	BHP	VOLT	PHASE	SCCR (KA)		ESP (IN WG)	RPM	TYPE	DIA.	DRIVE	HP	BHP	VOLT	PHASE	TOTAL					SENS	DB	WB	DB	WB	DB	WB																			DB	WB
AHU-1	DINING VAV AHU	4360	1635	360	1.75	2269	PLENUM	18.25	DIRECT	5	3.90	480	3	5	4360	0.80	1844	PLENUM	18.25	DIRECT	3	1.90	480	3	9.98	437	6	9	169	126	81.3	67.1	55.0	54.5	45	55	0.56	3.75	33.78	9.72	448	1	7	4.41	143	47	75	180	165	0.06	4.6	19.1				

UNIT HEATER SCHEDULE, ELECTRIC						
DESIG	KW	CFM	ELECTRICAL		TYPE	RECESS
			VOLT	PHASE		
UH-1	1.5	175	120	1	VERT	SINGLE SURFACE
UH-2	1.5	175	120	1	VERT	SINGLE SURFACE
UH-3	1.5	175	120	1	VERT	SINGLE SURFACE

VARIABLE AIR VOLUME UNIT SCHEDULE, HOT WATER HEAT												
DESIG	CFM			INLET SIZE	APD DESIGN FLOW (IN WG)	HEATING COIL						
	DESIGN COOLING	MINIMUM COOLING	HEATING			MBH	GPM	WPD (FT HD)	EWT (°F)	ROWS	EAT (°F)	LAT (°F)
VAV-1	1435	430	720	14	0.12	28.9	1.27	0.51	180	1	57	94
VAV-2	770	230	385	10	0.14	13.8	0.80	1.50	180	1	57	90
VAV-3	2155	645	1080	14	0.22	41.0	2.49	1.71	180	1	57	92

SPLIT SYSTEM CONDENSER-COMPRESSOR Vol 1									
DESIG	NOMINAL TONS	AIR ON COND (°F)	SEER	EER	ELECTRICAL				
					MCA	MOCP	VOLT	PHASE	SCCR (KA)
CU-2	1	95	23.1	13.5	10	15	208	1	5

SPLIT SYSTEM EVAPORATOR...				
*Powered through CU-2				
DESIG	CFM	MBH	TOTAL	SENS
SSAC-2	300	12	9	9


FAN SCHEDULE							
DESIG	CFM	ESP (IN WG)	HP (WATTS)	VOLT	PHASE	TYPE	DRIVE
EF-1	75	0.3	1/8	120	1	INLINE	DIRECT
EF-2	75	0.3	1/8	120	1	INLINE	DIRECT

CONDENSATE PUMP SCHEDULE*						
DESIG	GPM	PUMP HEAD	MOTOR			
			HP	VOLTAGE	PHASE	
CP-1	4	5.00 psi	1/8	120	1	

\*CONDENSATE PUMP TO INCLUDE 1-GALLON RECEIVER TANK.

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**H601**

COMMISSION NO: **2024109**

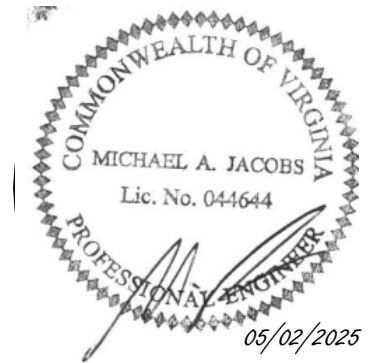DATE: **2 MAY 2025**

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