GATE VALVE	SYMBOLS GENERAL NOTES	GENERAL DEMOLITION NOTES
PLUMBING TO BE DEMOLISHED ———— DOMESTIC COLD WATER (CW) ———— DOMESTIC HOT WATER (HW) ———— DOMESTIC HOT WATER (HW) ————— SANITARY VENT (V) ————— SANITARY DRAIN (SAN) ————— SANITARY DRAIN (SAN) ———————————————————————————————————	E. ALL WORK INDICATED IS NEW UNITESS AND LOCATIONS OF EXISTING. F. VERIEY EXACT SIZES AND LOCATIONS OF EXISTING WORK PRIOR TO PROVIDING NEW WORK. G. SOME SYMBOLS INDICATED ON THIS LEGEND SHEET MAY NOT APPEAR ON THE DRAWINGS. H. DO NOT LOCATE PLUMBING WORK IN ELEVATOR, ELECTRICAL, OR COMMUNICATION ROOMS, EXCEPT FOR RUNOUTS SPECIFICALLY SERVING THE RESPECTIVE ROOM. 1. WATER HAMMER ARRESTORS SHALL BE INSTALLED, SIZED, AND LOCATED PER PDI WH-301. LOCATE WATER HAMMER RARRESTORS WITHIN 6 FEET OF QUICK ACTING VALVE. J. CONTRACTOR TO COORDINATE AND PROVIDE ACCESS PANELS FOR ALL COMPONENTS INSTALLED IN INACCESSIBLE AREAS THAT MAY REQUIRE MAINTENANCE. K. PROVIDE ALL MATERIALS AND EQUIPMENT AND PERFORM ALL LABOR REQUIRED TO INSTALL A COMPLETE AND OPERABLE PLUMBING SYSTEM AS INDICATED ON THE BRAYINGS, AS SPECIFIED, AND AS REQUIRED BY CODE. ALL MATERIALS SHE ENANGED BY CODE. ALL MATERIALS SHE PLUMBING SYSTEM AS INDICATED ON THE BRAYINGS, AS SPECIFIED, AND AS REQUIRED BY CODE. ALL MATERIALS SHE PLUMBING SYSTEM AS INDICATED ON THE BRAYINGS, AS SPECIFIED, AND AS REQUIRED BY CODE. ALL MATERIALS SHE PLUMBING SYSTEM AS INDICATED ON THE BRAYINGS, AS SPECIFIED, AND AS REQUIRED BY CODE. ALL MATERIALS SHE PLUMBING SYSTEM AND AS PROVINCES IN ACCORDANCE WITH MANIFER THE OUTPIECT OF CONTRACT DOCUMENTS, AND APPLICABLE CODES AND REGULATIONS. IN INSTALLA LLIPLUMBING EQUIPMENT AND APPLICABLE CODES AND REGULATIONS. M. HUNONS AND/DOR FLANGES SHALL BE INSTALLED FOR PUPICE OF EQUIPMENT AND IN BYPASSES TO PERMIT DISASSEMELY FOR ALTERATION AND REPAIRS. O. TYPICAL DETAILS THROUGHOUT THE DRAWING SET SETWED DISBINILAR MATERIALS. O. TYPICAL DETAILS THROUGHOUT THE DRAWING SET SETWED DISBINILAR MATERIALS. O. TYPICAL DETAILS THROUGHOUT THE DRAWING SET SHALL APPLY FOR ALL APPLY FOR	A DEMOLISH ALL PLUMBING FIXTURES, ASSOCIATED COMPONENTS, AND PIPING THAT WILL BE RENDERED OBSOLETE DUE TO CHANGES TO THE BUILDING. COORDINATE THE EXTENT OF DEMOLITION AND COMPONENTS TO REMAIN WITH THE NEW WORK SHEETS, FIELD VERIEY ACTUAL PIPE ROUTING. B SEMOVE ALL APPILOABLE PIPING TO WHERE IT CONNECTS TO ACTIVE MAINS THE NEW PIPING SHALL REMAIN LUNDER SLAD PIPING TO WHERE IT CONNECTS TO ACTIVE MAINS THE CONTINUE SHALL REMAIN LUNDER SLAD PIPING SHALL REMAIN LUNDER SLAD PIPING THAT IS REPORTED OSSOLETE BY CHANGES TO THE BUILDING CAN BE ABANDONED IN PLACE IF THE FOLLOWING CONDITIONS ARE MET: 1) INACTIVE PIPING SHALL BE DISCONNECTED AND CAPPED AS CLOSE AS POSS TO THE ACTIVE MAIN AND NO MORE THAN 2 TIME THE PIPE DIMBETER. 2) REMOVE PIPE STUDE-OUTS THROUGH THE SLAB AND REPAIR SLAB TO MATCH EXISTING. 3) DOES NOT CONFLICT WITH OTHER TRADES. C. BEFORE WORK HAS BEGUN, CONTRACTOR SHALL MAKE A THOROUGH SURVEY THE BUILDING AND NOTIFY THE OWNER OF ANY DISCREPANCIES BETWEEN PIPE SHAPPING SHALL WITH A CONTRACTOR TO HAVE ACCUMENTED HIMSELF WITH AVAILABLE INFORMATION OR SECRET OF THE CONTRACTOR TO HAVE ACCUMENTED HIMSELF WITH AVAILABLE INFORMATION OR SECRET OR THE CONTRACTOR TO REPORT OF THE CONTRACTOR OR REFERENCE ONLY AND HAVE BEEN DEVELOPED FROM EXISTING DRAWINGS AND ANY NOT REFLECT ACTUAL FIELD CONDITIONS. THE CONTRACTOR SHALL OST COPPOS OF EXISTING DRAWINGS AND ANY NOT REFLECT ACTUAL FIELD CONDITIONS. THE CONTRACTOR SHALL OST COPPOS OF EXISTING DRAWINGS AND WAY NOT REFLECT ACTUAL FIELD CONDITIONS. THE CONTRACTOR SHALL OST COPPOS OF EXISTING DRAWINGS AND WERE AVAILABLE IN THE CONDITIONS FIELD ON THE CONTRACT OR SHALL OST COPPOS OF EXISTING DRAWINGS AND WERE TO ACTUAL FIELD CONDITIONS. THE CONTRACTOR SHALL OST COPPOS OF EXERNED PROVINCES AND WERE THE PROPRIED IN THE CONTRACT OR SHALL OST COPPOS OF EXERNED BRAWNESS AND WERE THE PROPRIED BY THE CONTRACTOR SHALL OST COMMENTS. THE PROPRIED BY THE CONTRACTOR SHALL OST CON

PROJECT LEXINGTON CITY HALL RENOVATION

CLIENT

CITY OF LEXINGTON

300 E. WASHINGTON STREET LEXINGTON, VA 24450 540.462.3700 tel

CONSULTANT

AECOM

10 South Jefferson Street, Suite 1600
Roanoke, Virginia 24011
540.857.3100 tel 540.857.3180 fax
www.aecom.com

CONSULTANTS

REGISTRATION



ISSUE/REVISION

I 01/03/2025 FINAL DESIGN SUBMISSION I/R DATE DESCRIPTION

KEY PLAN


PROJECT NUMBER

SHEET TITLE

LEGEND AND GENERAL NOTES

SHEET NUMBER

©2016 AECOM Corporation

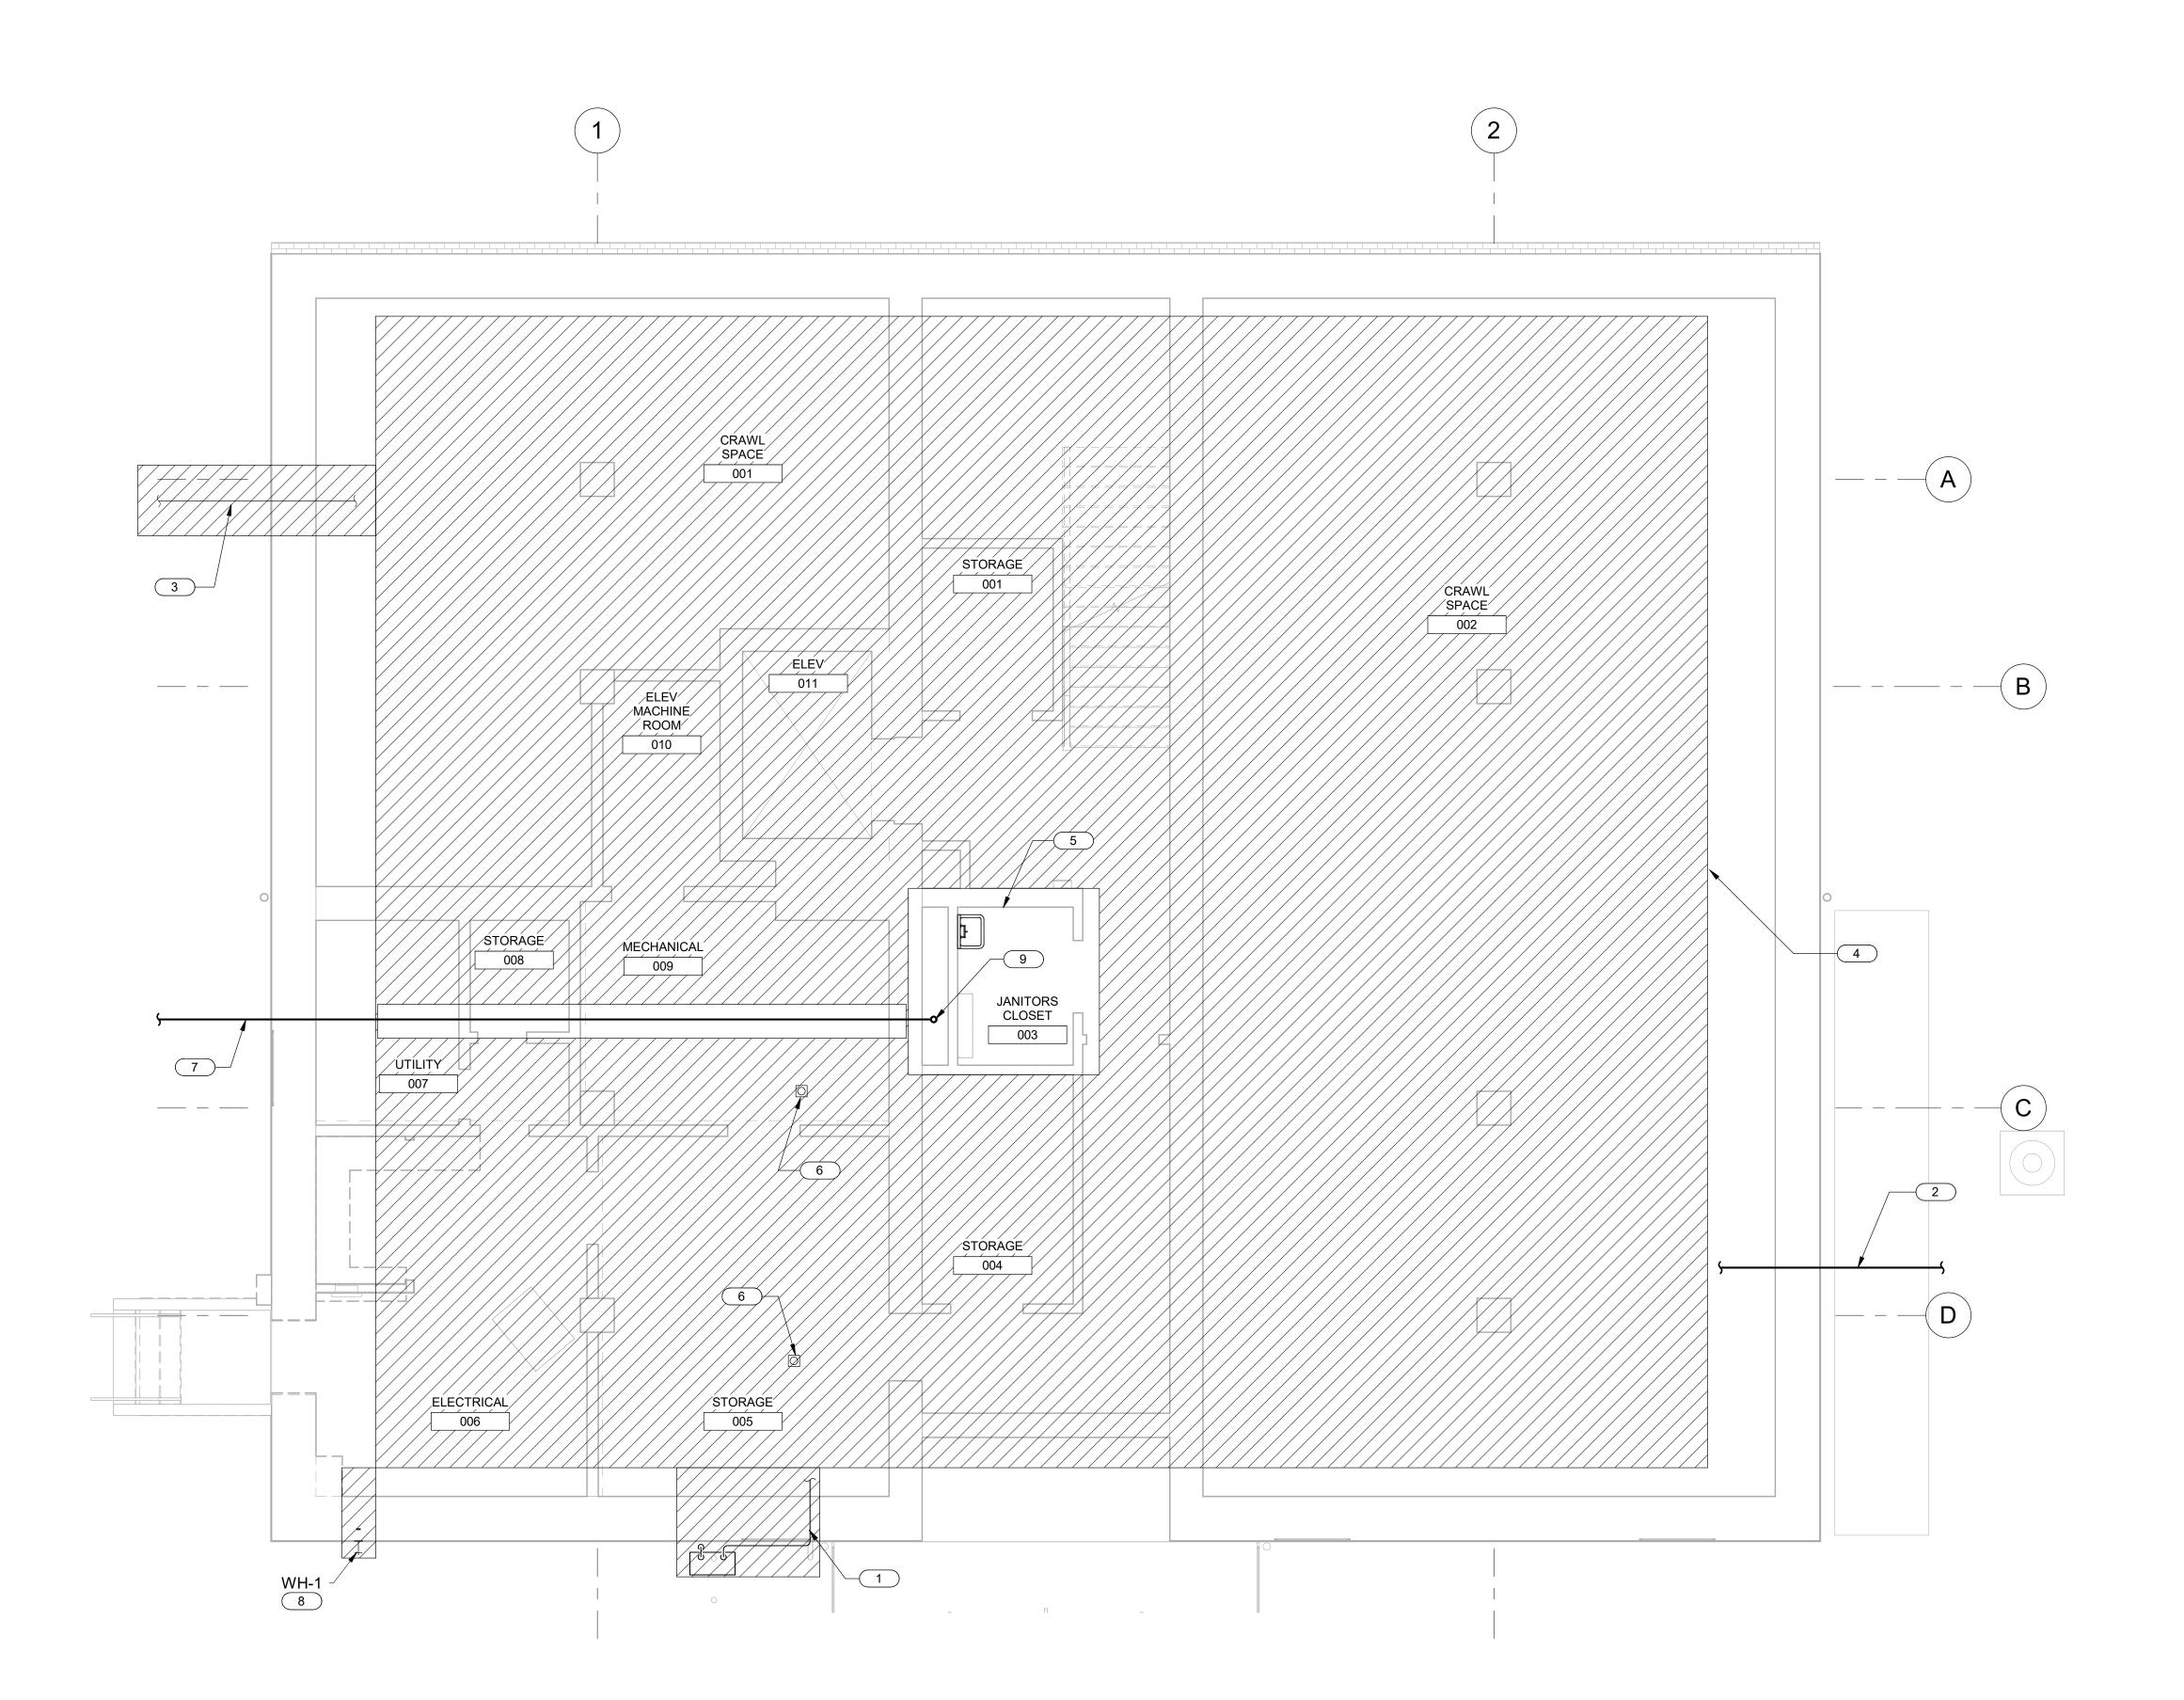

BASEMENT DEMOLITION PLAN 1/4" = 1'-0"

GENERAL NOTES THIS SHEET:



1 DEMOLISH 2" NATURAL GAS CONNECTION. COORDINATE METER REMOVAL WITH NATURAL MATCH EXISTING. DEMOLISH ALL REMAINING

- INTERIOR PIPING. 2 EXISTING 6" SANITARY. RETAIN FOR FUTURE USE AND DEMOLISH ALL INTERIOR PIPING. PREPARE SANITARY PIPING IN CRAWL SPACE FOR NEW
- EXTERIOR PIPING AND PREPARE FOR NEW LARGER
- 4 DEMOLISH ALL PLUMBING EXCEPT AS NOTED. DEMOLITION SHALL INCLUDE ALL SUPPLY, DRAIN,
- DEMOLISH JANITOR'S SINK, HW, AND CW PIPING. RETAIN EXISTING DRAIN AND VENT PIPING UP TO CONNECTION POINT. PREPARE CONNECTIONS FOR REPLACEMENT IN-KIND JANITOR'S SINK.
- 6 DEMOLISH ALL PLUMBING EXCEPT FOR FLOOR DRAIN AND ITS ASSOCIATED VENT UP TO CONNECTION POINT.
- REMOVE EXISTING WALL HYDRANT AND REPAIR MORTAR JOINT. PROVIDE NEW HYDRANT IN NEW LOCATION ON SHEET P-100.
- DRAIN PIPING, AS WELL AS VENT SERVING THOSE FIXTURES. CURRENT ROUTING IS UNKNOWN. RECONFIGURE VENT TO FIT NEW FLOOR PLANS ON UPPER FLOORS.

A. SEE SHEET P-001 FOR LEGEND AND GENERAL NOTES.

SHEET KEYNOTES:

GAS PROVIDER AND PATCH HOLES IN BUILDING TO

- CONNECTION. 3 EXISTING 1" WATERLINE. DEMOLISH INTERIOR AND
- PIPE IN NEW LOCATION.
- VENT, AND NATURAL GAS PIPING, AS WELL AS ALL FIXTURES AND EQUIPMENT.
- EXISTING 4" SANITARY. RETAIN AS-IS.
- RETAIN JANITORS SINK DRAIN PIPING, FLOOR

REGISTRATION

PROJECT

CLIENT

LEXINGTON

RENOVATION

CITY OF LEXINGTON

300 E. WASHINGTON STREET

10 South Jefferson Street, Suite 1600

Roanoke, Virginia 24011 540.857.3100 tel 540.857.3180 fax

LEXINGTON, VA 24450


540.462.3700 tel

CONSULTANT


www.aecom.com

CONSULTANTS

CITY HALL

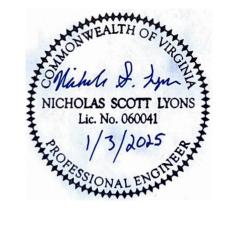

ISSUE/REVISION

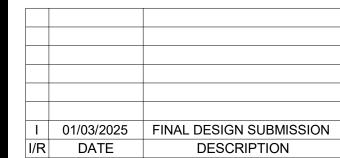

KEY PLAN

PROJECT NUMBER

SHEET TITLE BASEMENT DEMOLITION PLAN

SHEET NUMBER

GRAPHIC SCALES

©2016 AECOM Corporation READY FOR CONSTRUCTION

FIRST FLOOR DEMOLITION PLAN

GENERAL NOTES THIS SHEET:

A. SEE SHEET P-001 FOR LEGEND AND GENERAL NOTES.

SHEET KEYNOTES:

DEMOLISH ALL PLUMBING EXCEPT AS NOTED.
DEMOLITION SHALL INCLUDE ALL SUPPLY, DRAIN,
VENT, AND NATURAL GAS PIPING, AS WELL AS ALL
FIXTURES AND EQUIPMENT.

LEXINGTON CITY HALL RENOVATION

PROJECT

CLIENT

CITY OF LEXINGTON

300 E. WASHINGTON STREET LEXINGTON, VA 24450 540.462.3700 tel

CONSULTANT


10 South Jefferson Street, Suite 1600 Roanoke, Virginia 24011 540.857.3100 tel 540.857.3180 fax www.aecom.com

CONSULTANTS

REGISTRATION



ISSUE/REVISION

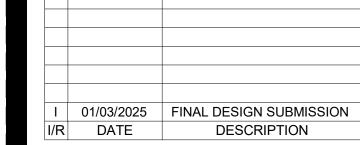

KEY PLAN

PROJECT NUMBER

SHEET TITLE

FIRST FLOOR DEMOLITION PLAN

SHEET NUMBER

©2016 AECOM Corporation READY FOR CONSTRUCTION

GRAPHIC SCALES

SECOND FLOOR DEMOLITION PLAN

GENERAL NOTES THIS SHEET:

A. SEE SHEET P-001 FOR LEGEND AND GENERAL NOTES.

SHEET KEYNOTES:

DEMOLISH ALL PLUMBING EXCEPT AS NOTED.
DEMOLITION SHALL INCLUDE ALL SUPPLY, DRAIN,
VENT, AND NATURAL GAS PIPING, AS WELL AS ALL
FIXTURES AND EQUIPMENT.

PROJECT LEXINGTON CITY HALL

CLIENT

CITY OF LEXINGTON

RENOVATION


300 E. WASHINGTON STREET LEXINGTON, VA 24450 540.462.3700 tel

CONSULTANT


10 South Jefferson Street, Suite 1600 Roanoke, Virginia 24011 540.857.3100 tel 540.857.3180 fax www.aecom.com

CONSULTANTS

REGISTRATION

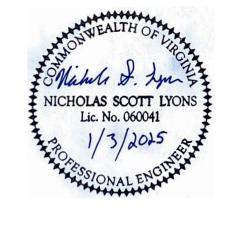

ISSUE/REVISION

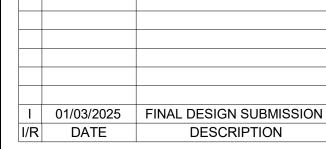

KEY PLAN

PROJECT NUMBER


SHEET TITLE

SECOND FLOOR DEMOLITION PLAN

SHEET NUMBER

GRAPHIC SCALES

©2016 AECOM Corporation READY FOR CONSTRUCTION

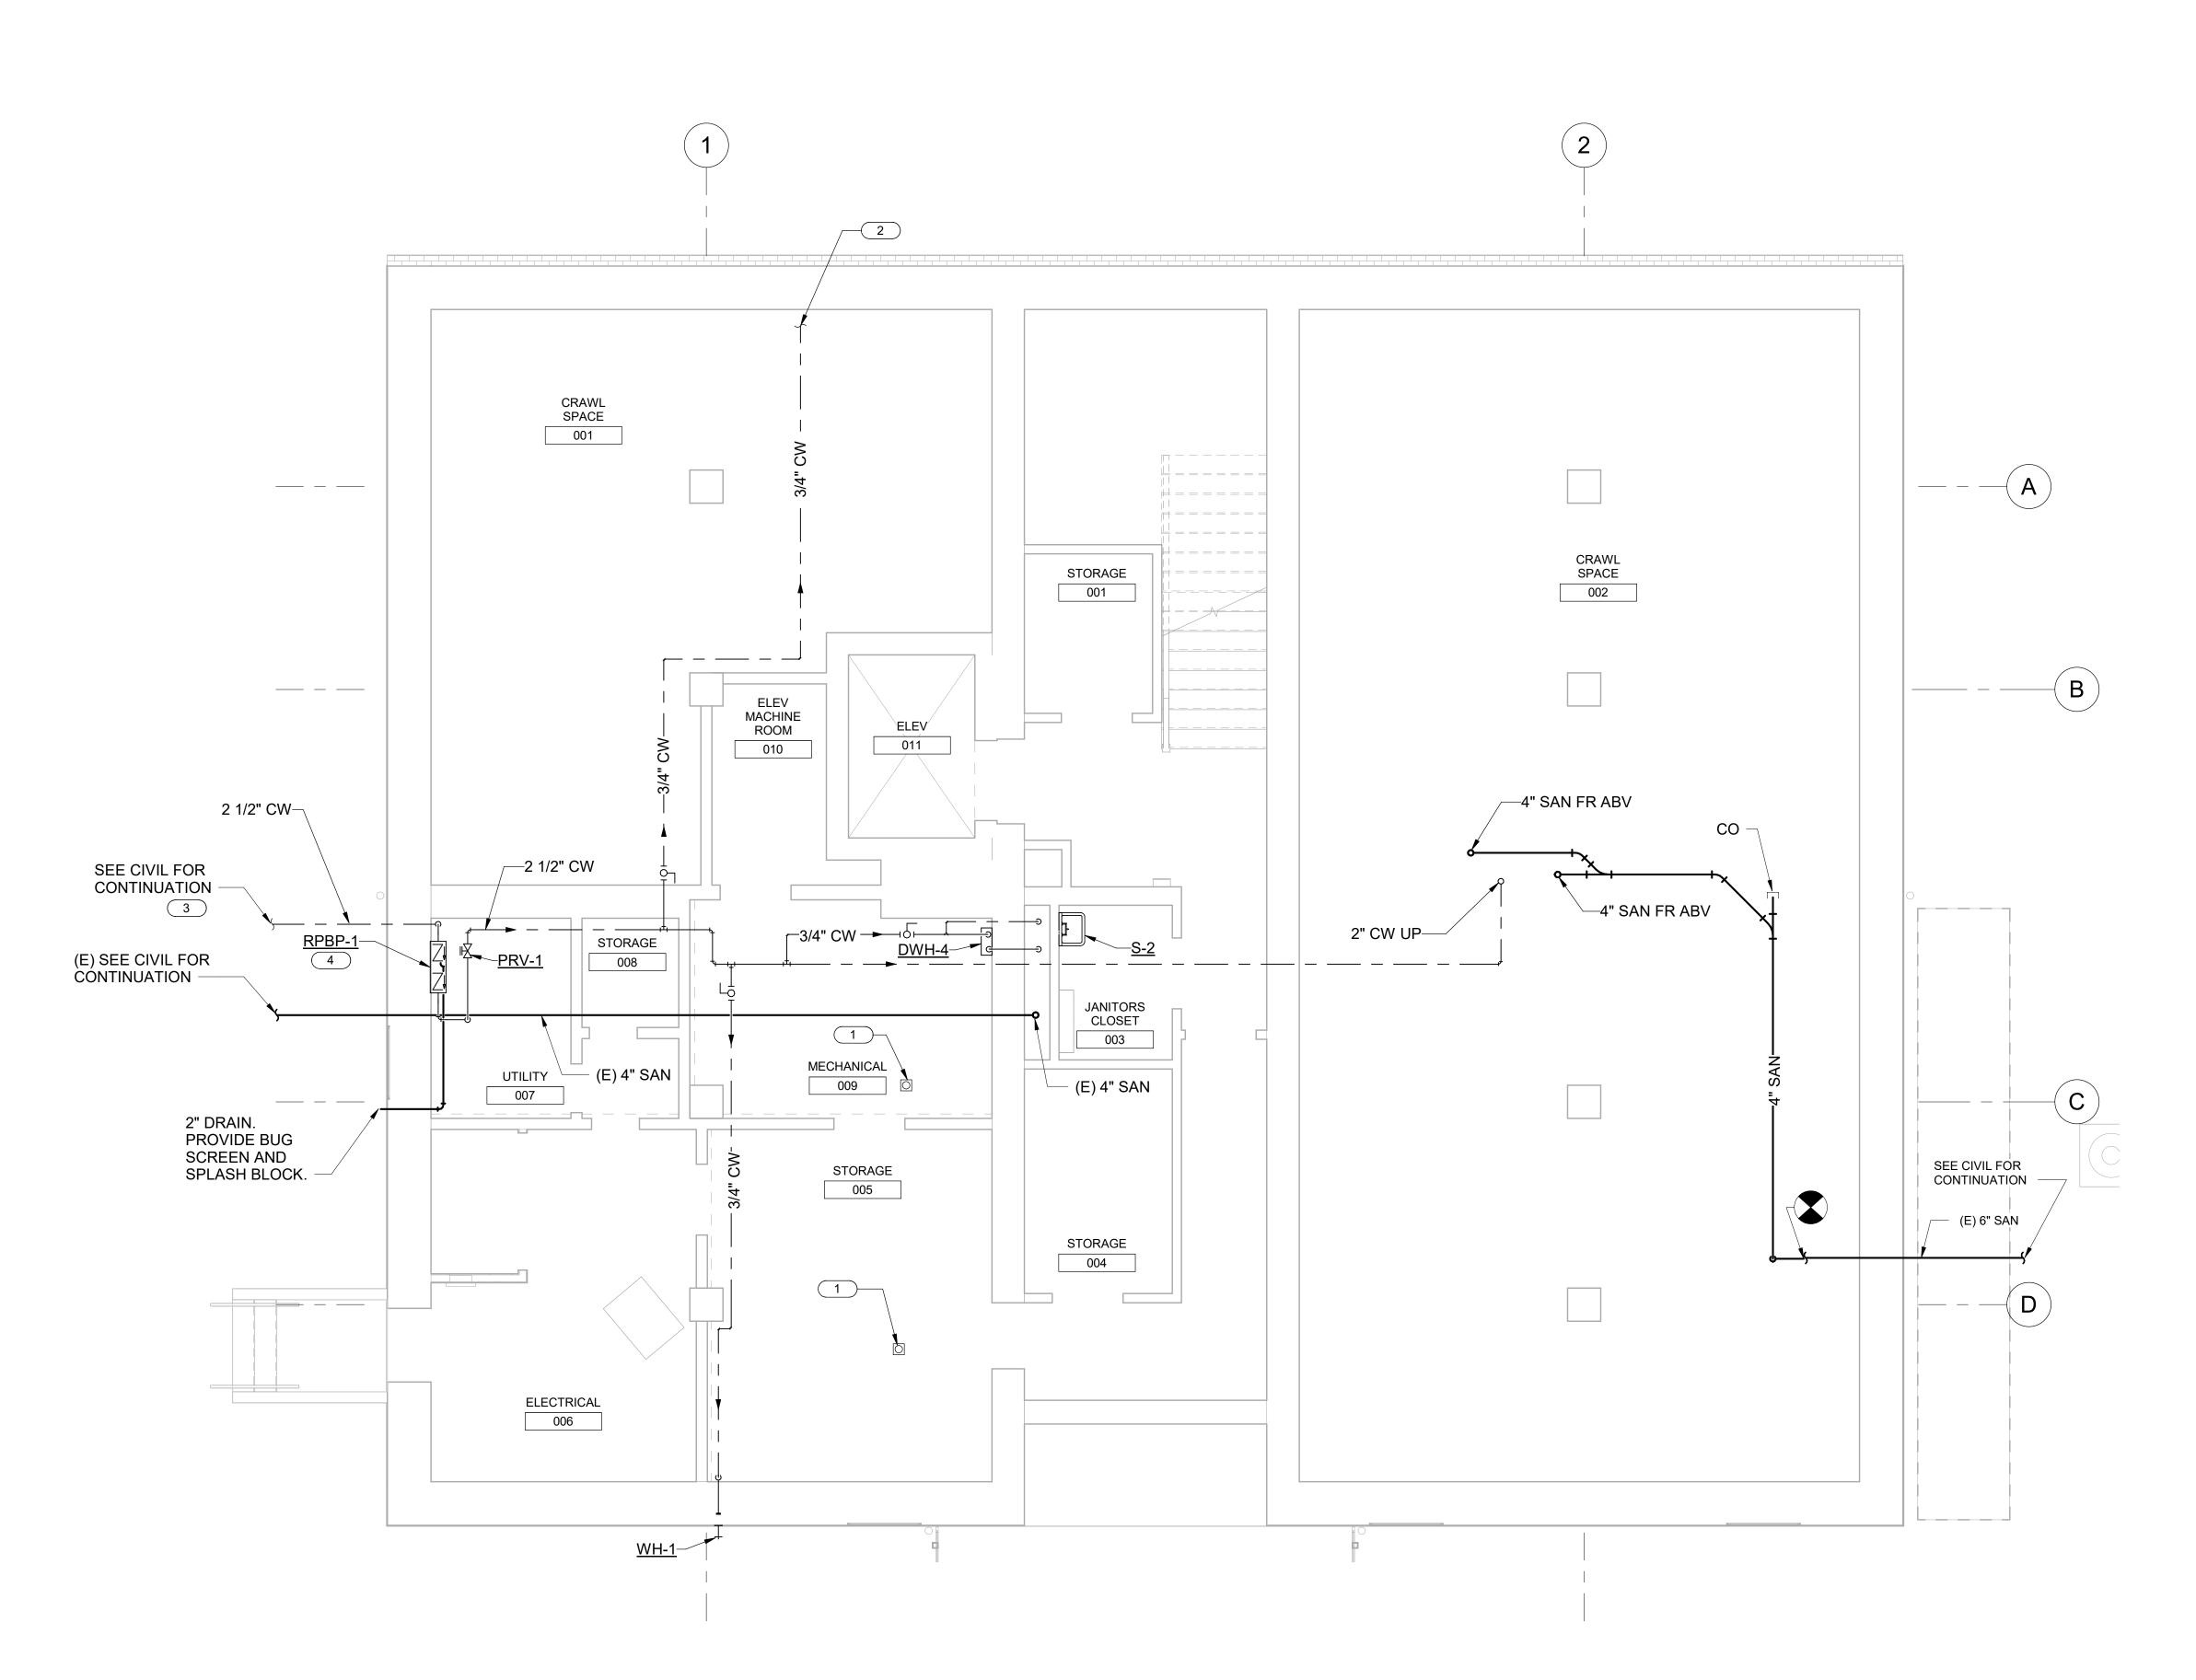

BASEMENT PLUMBING PLAN 1/4" = 1'-0"

GENERAL NOTES THIS SHEET:

A. SEE SHEET P-001 FOR LEGEND AND GENERAL NOTES.



- 1 EXISTING FLOOR DRAINS AND ASSOCIATED PIPING TO REMAIN.

- 4 SEE RPBP-1 CONNECTION DETAILS ON P-501 FOR MORE INFORMATION.



- 2 CONNECT NEW WATERLINE TO FIRST FLOOR WALL
- 3 SEE CIVIL DRAWINGS FOR NEW 2-1/2" WATERLINE AND 2" METER LOCATION. COORDINATE WITH CITY
- FOR METER REQUIREMENTS.

CLIENT

PROJECT

LEXINGTON

RENOVATION

CITY HALL

CITY OF LEXINGTON


300 E. WASHINGTON STREET LEXINGTON, VA 24450 540.462.3700 tel

CONSULTANT


10 South Jefferson Street, Suite 1600 Roanoke, Virginia 24011 540.857.3100 tel 540.857.3180 fax www.aecom.com

CONSULTANTS

REGISTRATION

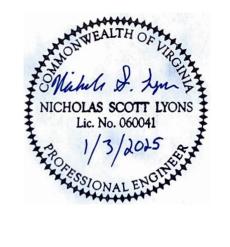

ISSUE/REVISION

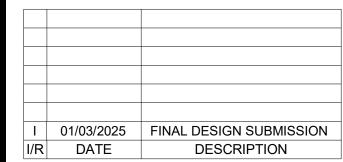

KEY PLAN

PROJECT NUMBER


SHEET TITLE

BASEMENT PLUMBING PLAN

SHEET NUMBER

©2016 AECOM Corporation READY FOR CONSTRUCTION

GRAPHIC SCALES

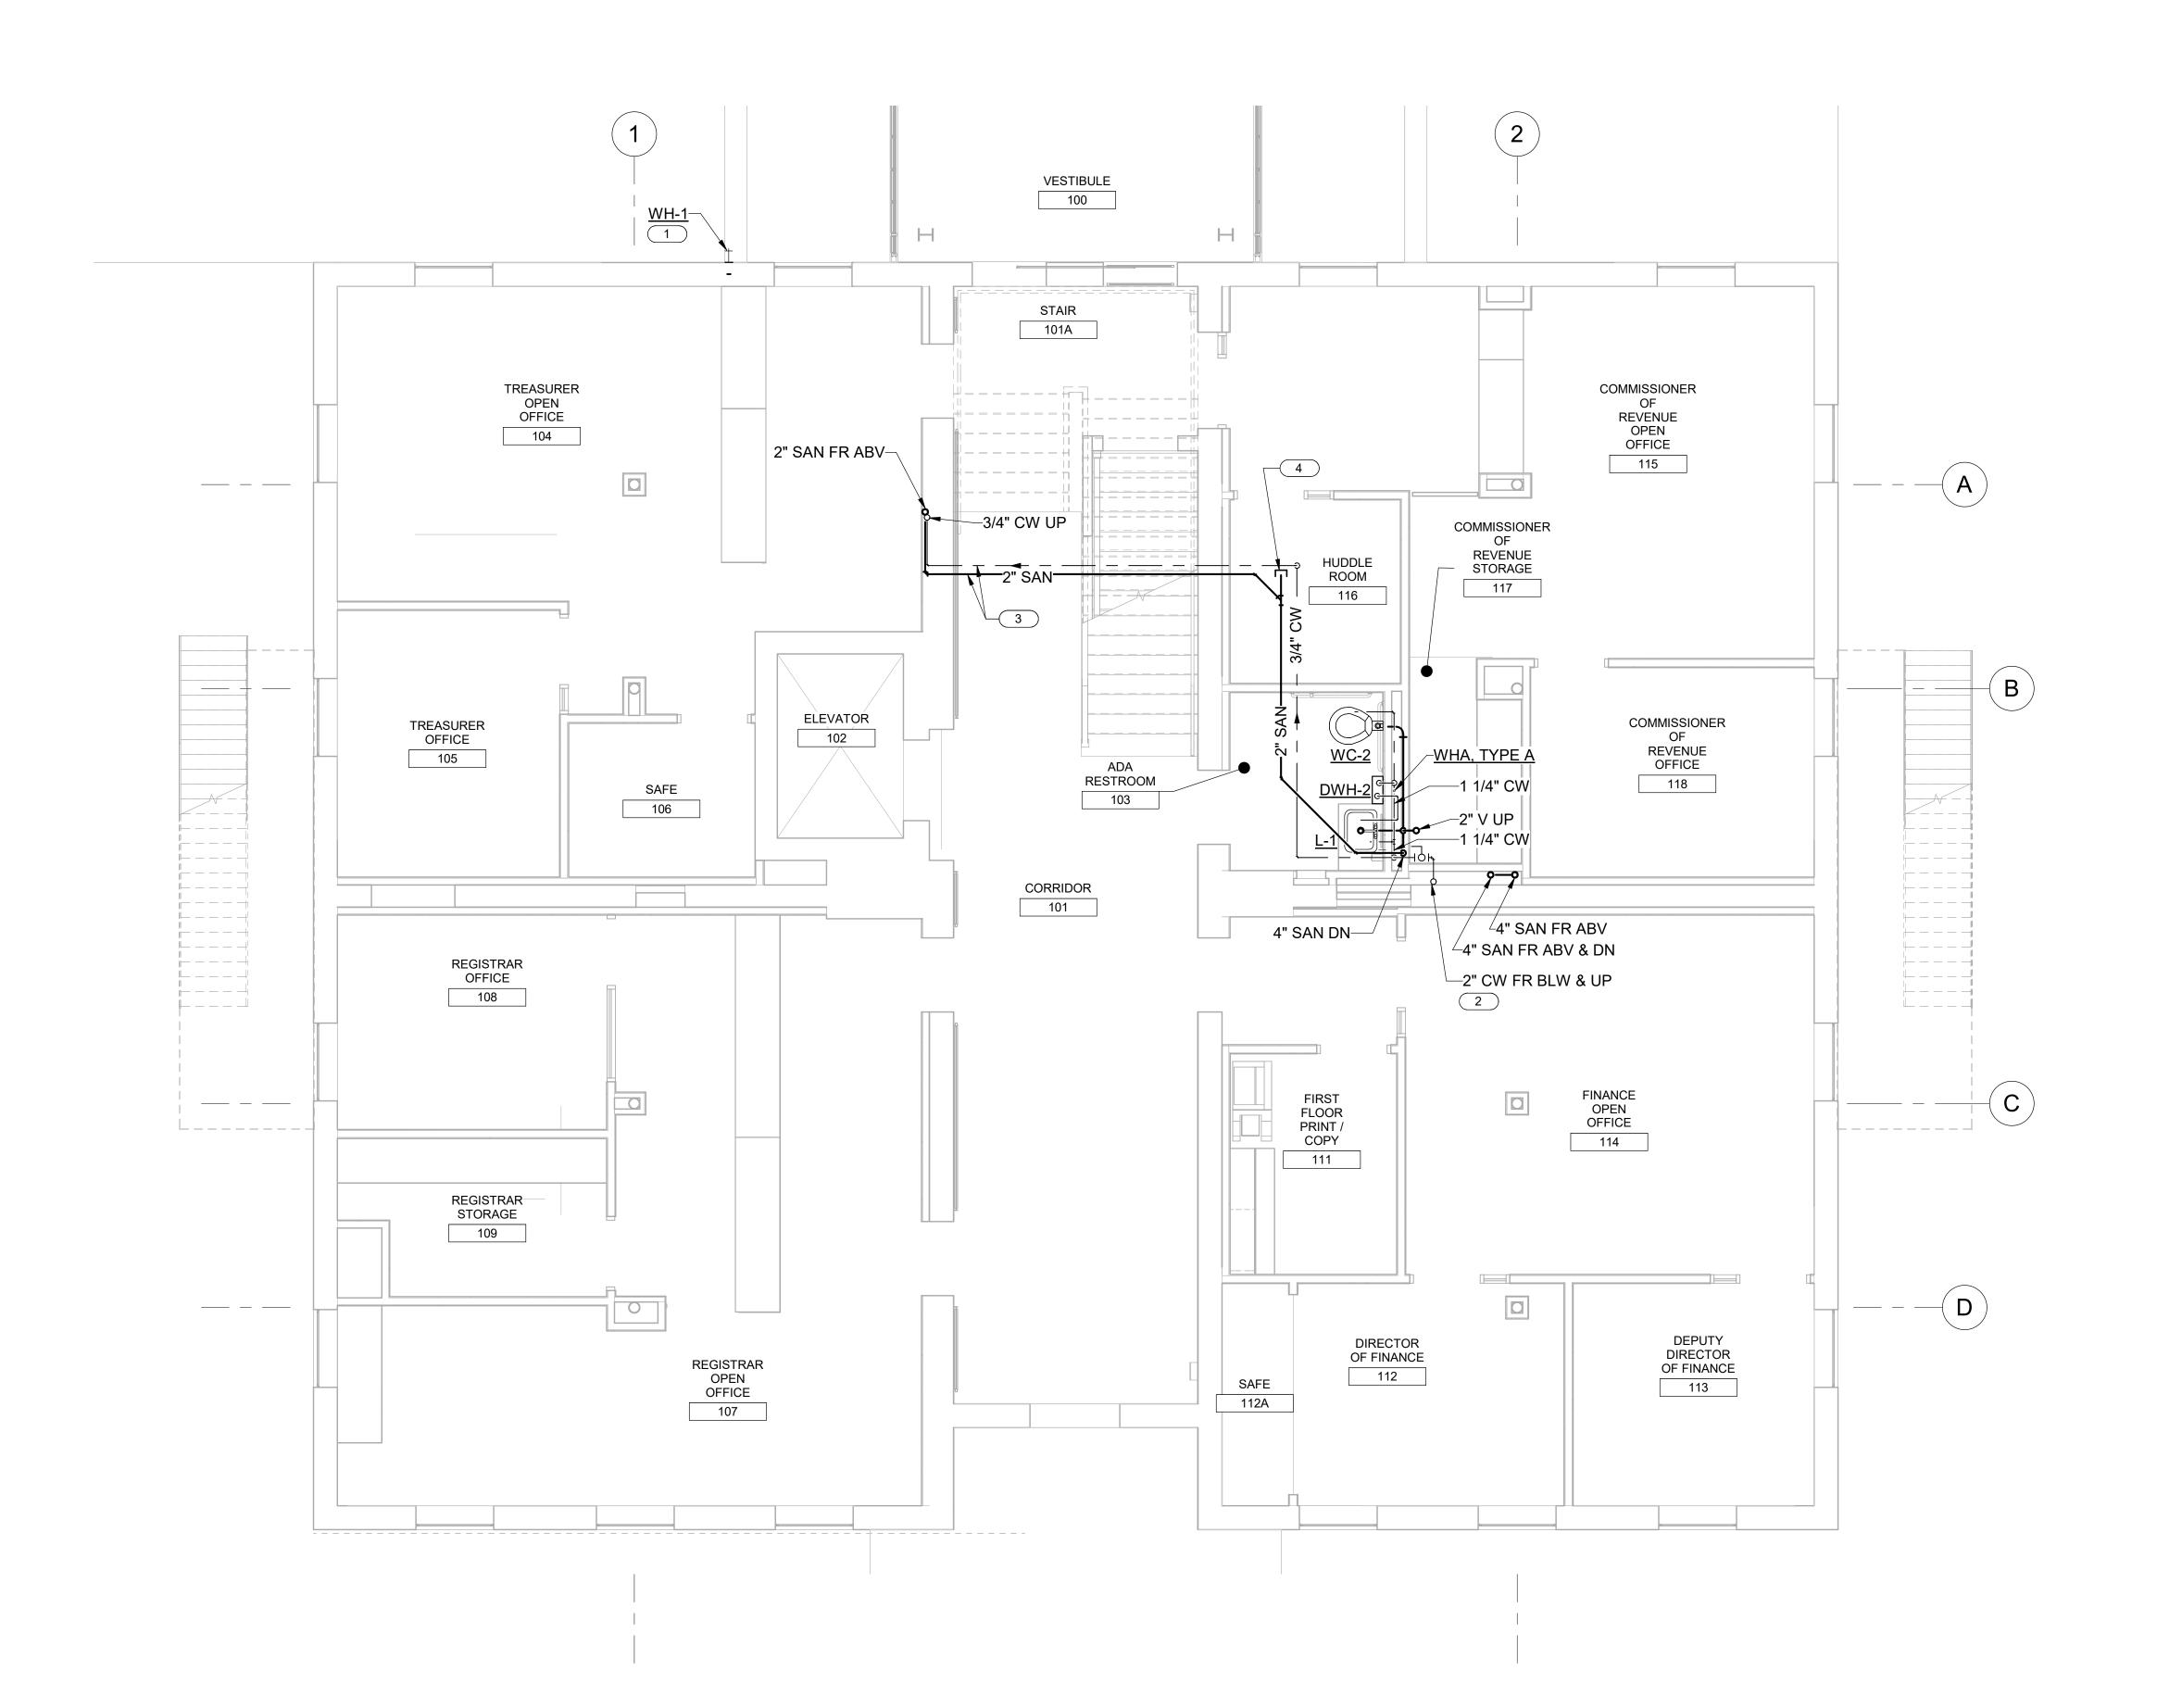

FIRST FLOOR PLUMBING PLAN 1/4" = 1'-0"

GENERAL NOTES THIS SHEET:

A. SEE SHEET P-001 FOR LEGEND AND GENERAL NOTES.

SHEET KEYNOTES: 1 CONNECT NEW WATERLINE TO FIRST FLOOR WALL

- HYDRANT.
- 2 PROVIDE SHUTOFF VALVE IN VERTICAL SUPPLY PIPE SERVING SECOND FLOOR. LOCATE ABOVE CEILING TILES.
- 3 ROUTE PIPING BETWEEN FLOOR JOISTS ABOVE BEADBOARD CEILING.
- 4 PROVIDE CLEANOUT ABOVE CEILING. COORDINATE LOCATION TO AVOID LIGHTING, DUCTWORK, AND FIRE PROTECTION DEVICES.

PROJECT LEXINGTON CITY HALL RENOVATION

CLIENT

CITY OF LEXINGTON 300 E. WASHINGTON STREET LEXINGTON, VA 24450

AECOM


540.462.3700 tel

CONSULTANT


10 South Jefferson Street, Suite 1600 Roanoke, Virginia 24011 540.857.3100 tel 540.857.3180 fax www.aecom.com

CONSULTANTS

REGISTRATION

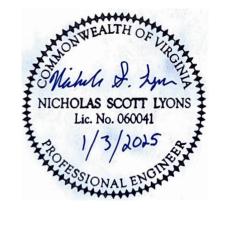

ISSUE/REVISION

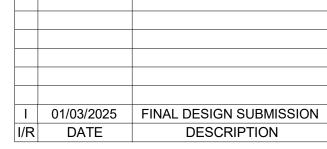

KEY PLAN

PROJECT NUMBER

SHEET TITLE


FIRST FLOOR PLUMBING PLAN

SHEET NUMBER

READY FOR CONSTRUCTION

GRAPHIC SCALES

©2016 AECOM Corporation

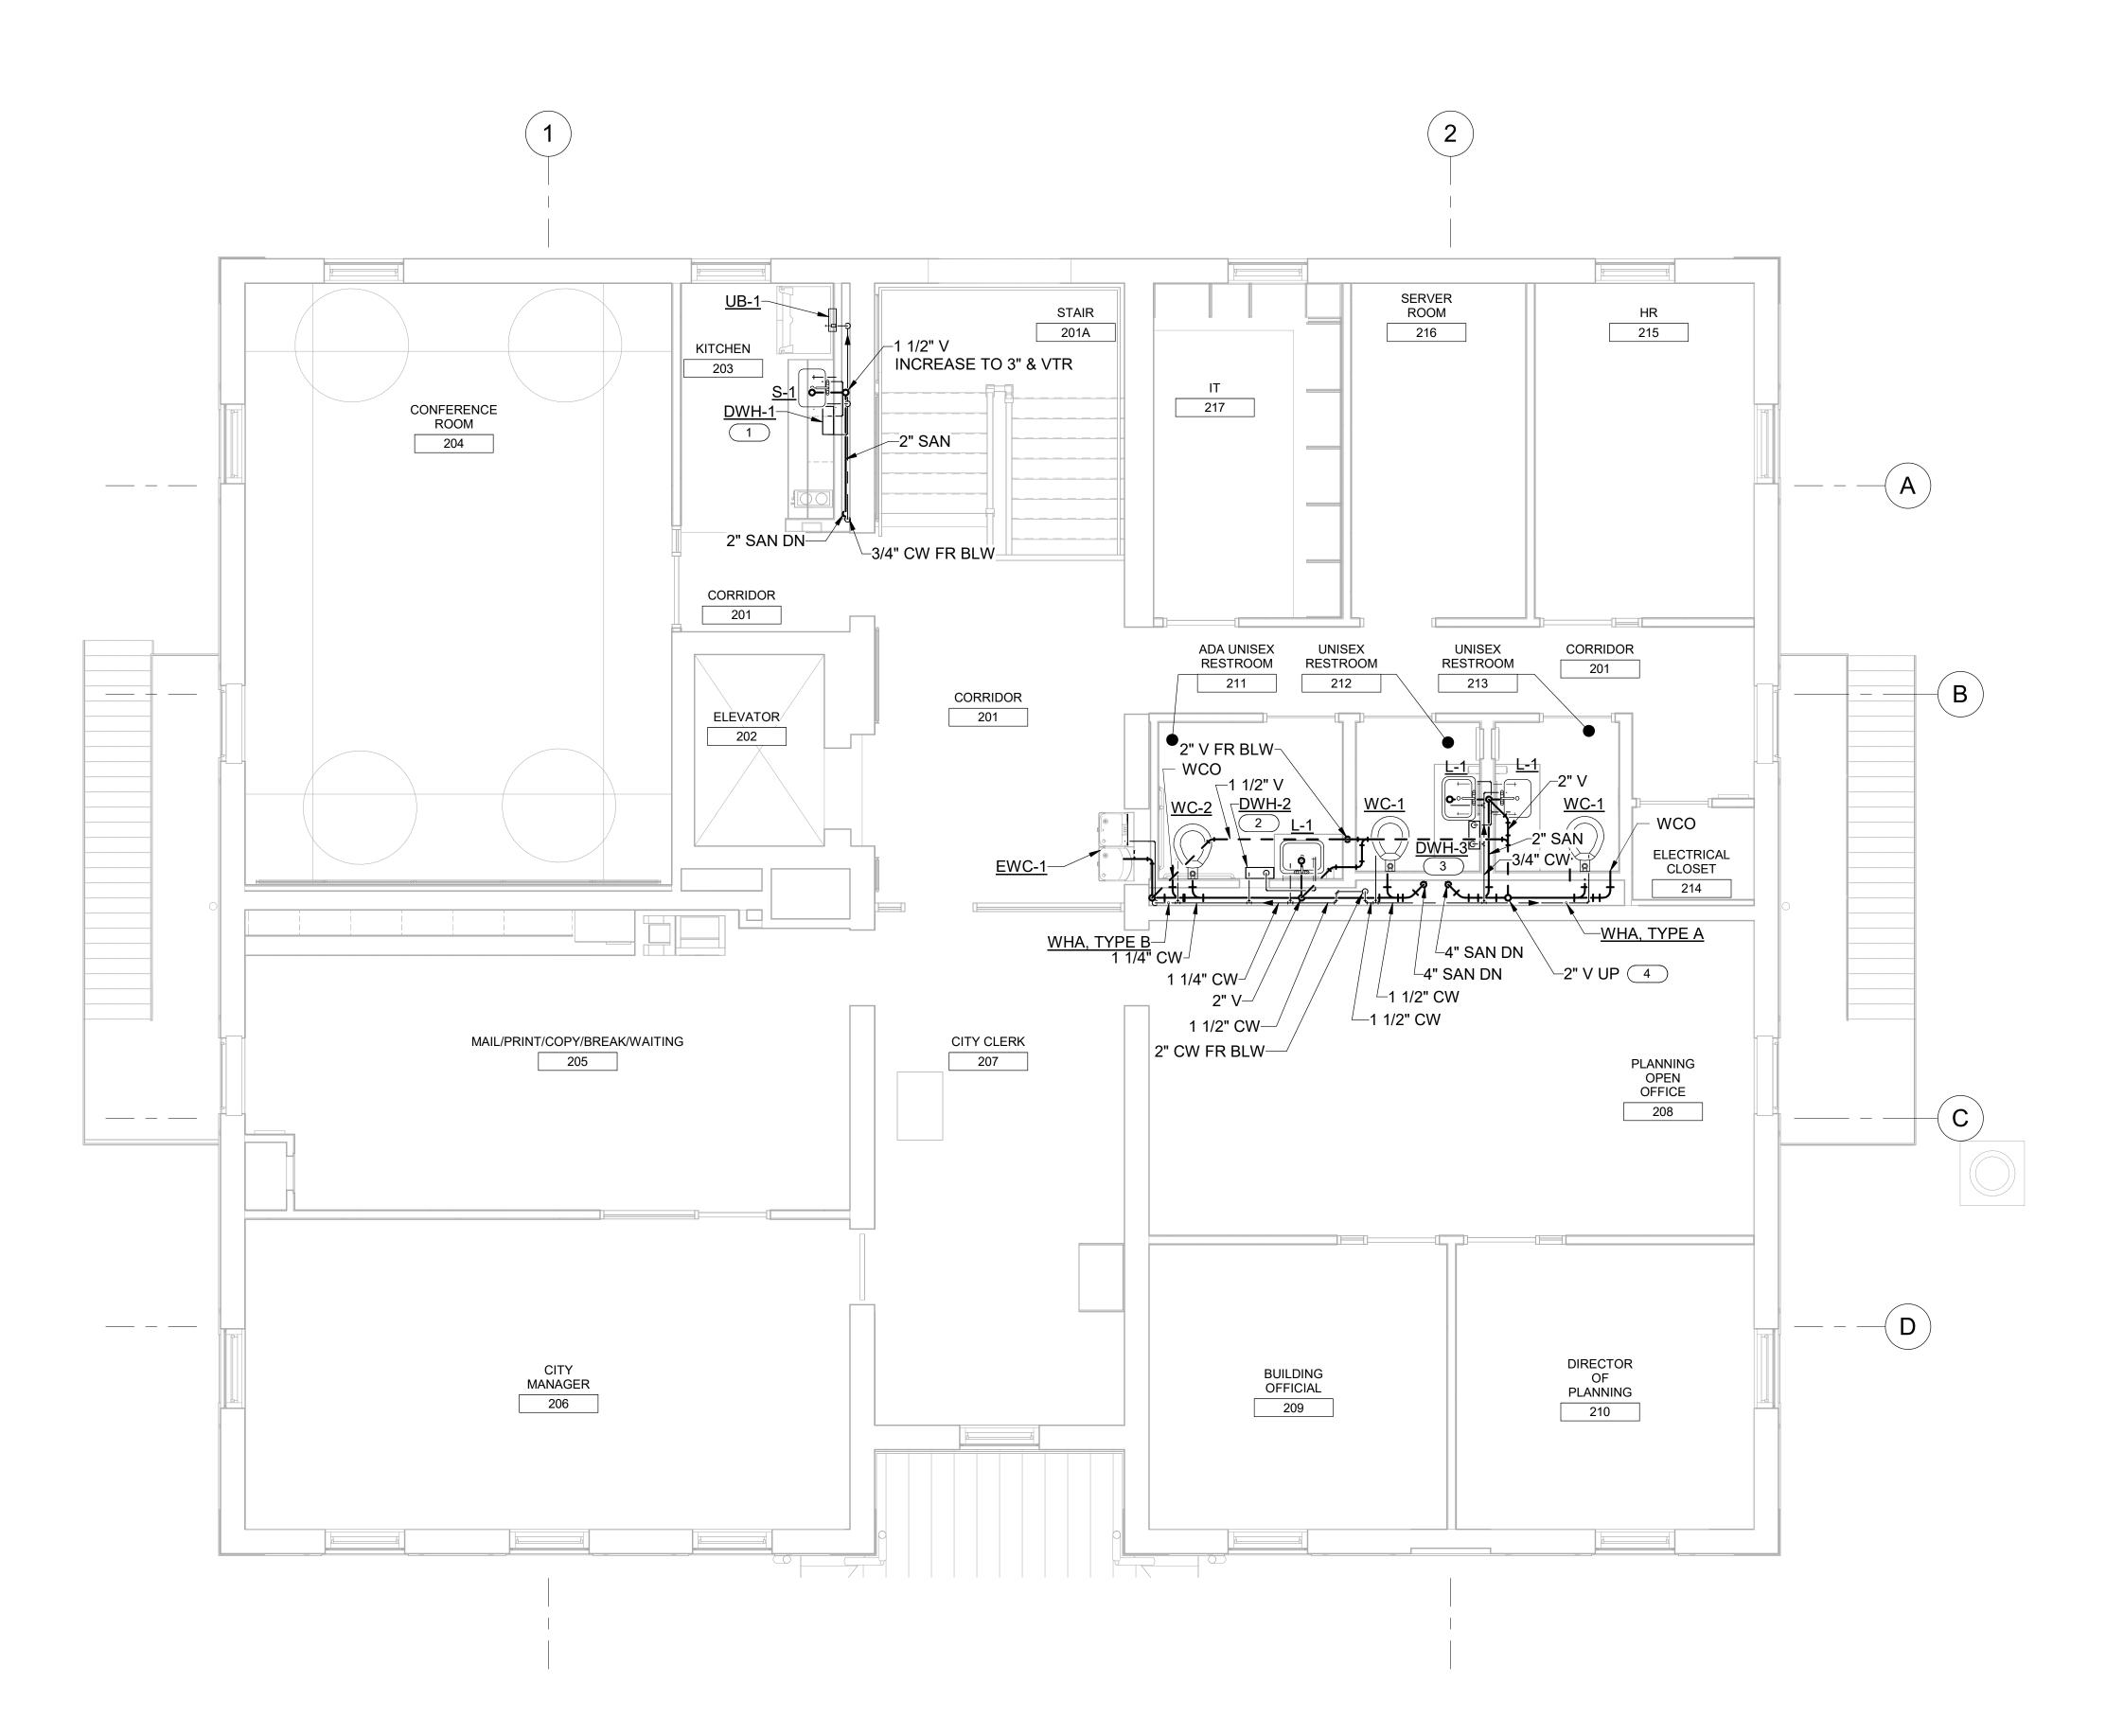

SECOND FLOOR PLUMBING PLAN 1/4" = 1'-0"



A. SEE SHEET P-001 FOR LEGEND AND GENERAL NOTES.

SHEET KEYNOTES:

- 1 SHOWN OUT OF POSITION FOR CLARITY. MOUNT DWH IN CABINET BELOW SINK.
- 2 SHOWN OUT OF POSITION FOR CLARITY. MOUNT DWH BELOW LAVATORY. 3 SHOWN OUT OF POSITION FOR CLARITY. MOUNT DWH BELOW LAVATORY AND PIPE TO SERVE RESTROOMS
- TIE NEW VENT TO EXISTING VENT PIPING IN ATTIC. REUSE EXISTING VENT THROUGH ROOF.

LEXINGTON CITY HALL RENOVATION

CLIENT

PROJECT

CITY OF LEXINGTON 300 E. WASHINGTON STREET

LEXINGTON, VA 24450

540.462.3700 tel


CONSULTANT

10 South Jefferson Street, Suite 1600 Roanoke, Virginia 24011 540.857.3100 tel 540.857.3180 fax


www.aecom.com

CONSULTANTS

REGISTRATION

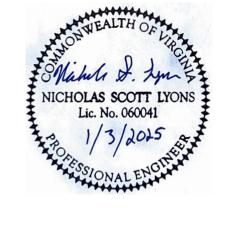

ISSUE/REVISION

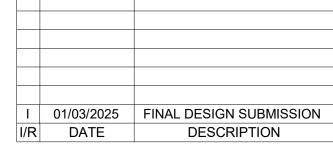

KEY PLAN


PROJECT NUMBER

SHEET TITLE SECOND FLOOR PLUMBING PLAN

SHEET NUMBER

©2016 AECOM Corporation READY FOR CONSTRUCTION

GRAPHIC SCALES

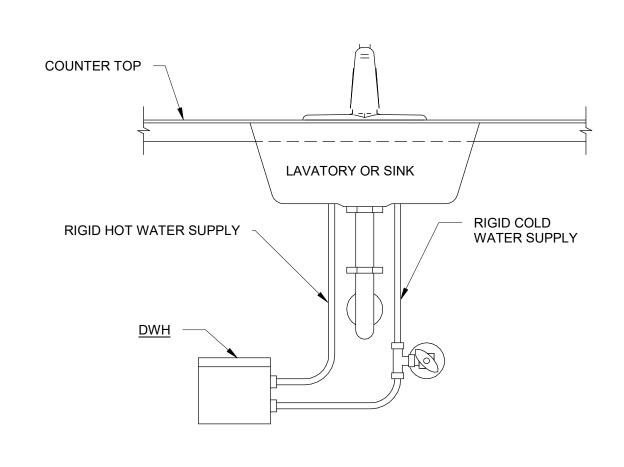

INSTANTANEOUS WATER HEATER NO SCALE


VARIES____

REDUCER (IF REQUIRED)


- CLEANOUT FITTING

- WATERPROOF SLEEVE

NOTE:
PROVIDE WALL CLEANOUT FOR
FIRST FLOOR SANITARY STACKS.

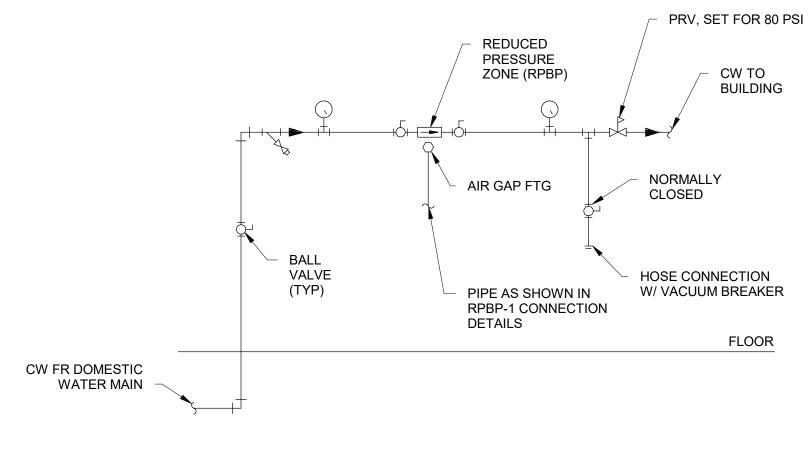

WATER SERVICE ENTRANCE DETAIL NO SCALE

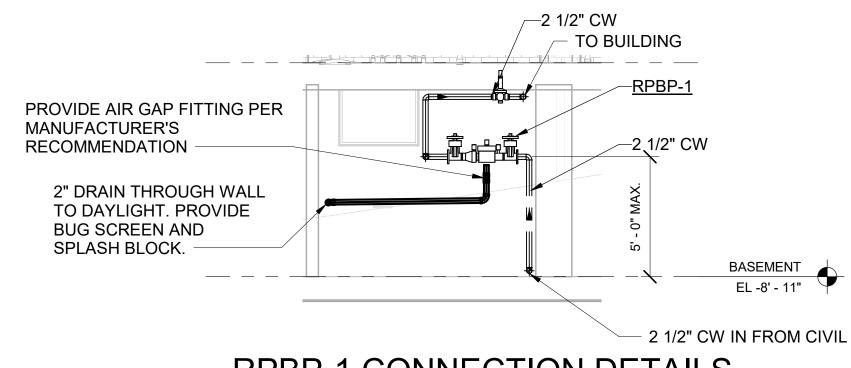

RPBP-1 CONNECTION DETAILS 1/4" = 1'-0"



PROJECT LEXINGTON CITY HALL RENOVATION

CLIENT

CITY OF LEXINGTON 300 E. WASHINGTON STREET LEXINGTON, VA 24450

540.462.3700 tel CONSULTANT

AECOM 10 South Jefferson Street, Suite 1600 Roanoke, Virginia 24011 540.857.3100 tel 540.857.3180 fax www.aecom.com

CONSULTANTS

REGISTRATION



ISSUE/REVISION

01/03/2025 FINAL DESIGN SUBMISSION I/R DATE

KEY PLAN

PROJECT NUMBER

SHEET TITLE

DETAILS

SHEET NUMBER

CONTINUOUS WATERPROOF SEALANT BEAD

STAINLESS STEEL ACCESS

SOIL/WASTE PIPE

	PLUMBING FIXTURE SCHEDULE											
MARK	FIXTURE DESCRIPTION	MOUNTING HEIGHT	COLD WATER SIZE	HOT WATER SIZE	TEMPERED WATER SIZE	TRAP SIZE	DRAIN SIZE	VENT SIZE	NOTES			
EWC-1	BI-LEVEL WATER COOLER W/ BOTTLE FILLER	PER ADA	1/2"	-	-	1 1/4"	1 1/2"	1 1/2"	-			
L-1	UNDERMOUNT LAVATORY, 0.5 GPM	COUNTERTOP	1/2"	1/2"	3/8"	1 1/4"	1 1/2"	1 1/2"	PROVIDE ASSE 1070 POINT OF USE MIXING VALVE UNDER FIXTURE OR GROUP OF FIXTURES AND SET AT 105° F. VALVE SHALL BE CAPABLE OF SUPPLYING REQUIRED FLOW OF FIXTURE(S) BEING SERVED.			
S-1	UNDERMOUNT SINGLE-BASIN SINK, 1.5 GPM	COUNTERTOP	1/2"	1/2"	1/2"	1 1/2"	1 1/2"	1 1/2"	PROVIDE ASSE 1070 POINT OF USE MIXING VALVE UNDER FIXTURE AND SET AT 105° F.			
S-2	STAINLESS WALL HUNG SERVICE SINK, 4.0 GPM	27-3/4" TO FLOOD RIM LEVEL	1/2"	1/2"	1/2"	-	-	-	PROVIDE ASSE 1070 POINT OF USE MIXING VALVE UNDER FIXTURE AND SET AT 105° F. REUSE EXISTING DRAIN AND VENT CONNECTIONS.			
UB-1	UTILITY BOX, COLD ONLY	18" AFF	1/2"	-	-	-	-	-	PROVIDE WHA-AA FOR CW CONNECTION. MOUNT UTILTY BOX FOR REFRIGERATOR 18" AFF.			
WC-1	WALL HUNG WATER CLOSET, MANUAL FLUSH VALVE, 1.28 GPF	15" TO FLOOD RIM LEVEL	1"	-	-	INTEGRAL	4"	2"	FOR ADA COMPLIANT FIXTURES, FLUSH VALVE CONTROLS SHALL BE LOCATED ON THE OPEN SIDE OF THE FIXTURE. COORDINATE INSTALLATION OF FLUSH VALVE WITH GRAB BAR FOR WATER CLOSETS. REFER TO ARCHITECTURAL DRAWINGS.			
WC-2	WALL HUNG WATER CLOSET, MANUAL FLUSH VALVE, ADA, 1.28 GPF	17" TO FLOOD RIM LEVEL	1"	-	-	INTEGRAL	4"	2"	FOR ADA COMPLIANT FIXTURES, FLUSH VALVE CONTROLS SHALL BE LOCATED ON THE OPEN SIDE OF THE FIXTURE. COORDINATE INSTALLATION OF FLUSH VALVE WITH GRAB BAR FOR WATER CLOSETS. REFER TO ARCHITECTURAL DRAWINGS.			
WH-1	WALL HYDRANT	MATCH EXISTING	3/4"	-	-	-	-	-	-			

	WATER HEATER SCHEDULE										
	DESCRIPTION	MIN. STORAGE (GAL)	E.W.T (F)	L.W.T. (F)	RECOVERY (GPH)	HEATER SIZE					
MARK						HEIGHT	WIDTH	MIN. INPUT	VOLTAGE/PHASE	NOTES	
DWH-1	MINI TANK WATER HEATER, ELECTRIC	1.5	56	140	7	14.29"	9.72"	1.4 kW	120/1		
DWH-2	INSTANTANEOUS WATER HEATER, ELECTRIC	-	56	110	-	9.73"	5.25"	4.1 kW	208/1	UNIT SHALL HAVE MINIMUM TURN ON FLOW OF 0.2 GPM.	
DWH-3	INSTANTANEOUS WATER HEATER, ELECTRIC	-	56	110	-	9.73"	5.25"	8.3 kW	208/1	UNIT SHALL HAVE MINIMUM TURN ON FLOW OF 0.2 GPM.	
DWH-4	MINI TANK WATER HEATER, ELECTRIC	4	56	140	7	17.31"	12.27"	1.4 kW	120/1	CONNECT TO NEW S-2. LOCATION SHOWN IS DESIRED BUT CAN BE LOCATED INSIDE JANITORS CLOSET IF ROOM IS AVAILABLE.	

	PIPE ACCESSORY SCHEDULE										
MARK	DESCRIPTION	CAPACITY (GPM)	MIN. FLOW (GPM)	COLD E.W.T (F)	HOT E.W.T. (F)	L.W.T. (F)	CIRCULATION E.W.T (F)	MAX. PRESSURE DROP (PSIG)	LINE SIZE (IN)	NOTES	
PRV-1	PRESSURE REDUCING VALVE	52	-	-	-	-	-	1	2-1/2	SET AT 80 PSI OUTGOING PRESSURE	
RPBP-1	REDUCED PRESSURE BACKFLOW PREVENTER	52	-	-	-	-	-	10	2-1/2	-	
WM-1	WATER METER	52	1	-	-	-	-	1	2"	SEE CIVIL DRAWINGS FOR LOCATION. COORDINATE METER AND INSTALLATION WITH CITY OF LEXINGTON WATER AND	

PLUMBING SPECIFICATIONS

GENERAL:

PROVIDE AND TEST COMPONENTS IN ACCORDANCE WITH THE VIRGINIA PLUMBING CODE (2021), MANUFACTURERS INSTRUCTIONS, AND APPROVED PRODUCT DATA SUBMITTALS.

PIPING MATERIALS, PLUMBING FIXTURES, AND EQUIPMENT SHALL BEAR WARNING SIGNS, LABELS, STAMPS, OR OTHER MARKINGS OF SPECIFIED TESTING AGENCY.

CLEAN INTERIOR OF PIPING. REMOVE DIRT AND DEBRIS AS WORK PROGRESSES.

PROTECT PIPING DURING REMAINDER OF CONSTRUCTION PERIOD TO AVOID CLOGGING WITH DIRT

AND DEBRIS AND TO PREVENT DAMAGE FROM TRAFFIC AND CONSTRUCTION WORK.

DRAWINGS INDICATE ONLY A GENERAL ARRANGEMENT OF PIPING, FITTINGS, AND SPECIALTIES. CONTRACTOR SHALL PROVIDE CUT SHEETS OF ALL EQUIPMENT, FIXTURES, AND PIPING FOR ENGINEER REVIEW. CUT SHEETS SHALL SHOW MARKINGS OF SPECIFIED TESTING AGENCY AND

SANITARY WASTE AND VENT PIPING (ABOVE GROUND):

CLEARLY INDICATE THE SELECTED MODEL.

- A. MATERIAL: HUBLESS CAST IRON
- B. PIPE: ASTM A 888, CISPI STD 301 C. FITTINGS: CISPI STD 310
- D. COUPLINGS: ASTM C 1277

SANITARY WASTE AND VENT PIPING (UNDERGROUND):

- A. MATERIAL: PVC. B. PIPE: ASTM D 2665.
- C. FITTINGS: ASTM D 2665.
- D. INSTALL UNDERGROUND PVC PIPING ACCORDING TO ASTM D 2321.
- DOMESTIC WATER PIPING:

ABOVE GROUND

- A. MATERIAL: COPPER TYPE L.
- B. PIPE: ASTM B88. CAST- OR WROUGHT- COPPER C. FITTINGS: CAST COPPER, SOLDER JOINT ASME B32, LEAD-FREE ALLOYS.
- D. JOINTS: BRAZED OR SOLDERED

BELOW GROUND A. MATERIAL: COPPER TYPE K.

- B. PIPE: ASTM B88 SOFT WROUGHT-COPPER. C. FITTINGS: CAST COPPER, SOLDER JOINT ASME B32, LEAD-FREE ALLOYS.
- D. JOINTS: BRAZED

PIPING INSULATION:

A. COLD WATER PIPE 1 INCH AND SMALLER: FLEXIBLE ELASTOMERIC OR GLASS-FIBER, TYPE 1 - 1/2 B. COLD WATER PIPE 1-1/4 INCHES AND LARGER: FLEXIBLE ELASTOMERIC OR GLASS-FIBER, TYPE 1 -1/2 INCH THICK C. HOT WATER PIPE 4 INCH AND SMALLER: FLEXIBLE ELASTOMERIC - 3/4 INCH THICK OR GLASS-FIBER, TYPE 1 - 1/2 INCH THICK.

VALVES:

ALL VALVES SHALL BE RATED FOR THEIR WORKING FLUID/GAS TEMPERATURE AND PRESSURE. BALL VALVES 2 INCHES AND SMALLER SHALL BE BRASS OR BRONZE WITH THREADED BODIES FOR PIPE AND SOLDER-TYPE CONNECTIONS FOR TUBING.

Y-TYPE STRAINERS SHALL HAVE CAST IRON BODY IN ACCORDANCE WITH ASTM A 126.

VALVE TAGS SHALL BE BRASS AND STAMPED OR ENGRAVED WITH 1/2 INCH LETTERS FOR PIPING SYSTEM ABBREVIATION AND 1/2 INCH NUMBERS FOR PIPE SIZE. TAGS SHALL BE ATTACHED BY BRASSWIRE-LINK CHAIN.

METERS AND GAGES

PRESSURE GAGES SHALL BE DIRECT-MOUNTED, METAL-CASE, DIAL-TYPE WITH GLASS WINDOW,

WATER HEATERS (DWH-1 & DWH-4):

INSTANTANEOUS WATER HEATERS (DWH-2 & DWH-3)

BASIS OF DESING: EEMAX LAVADVANTAGE SERIES

WATER CLOSETS (WC-1 & WC-2)

B. TYPE: WALL MOUNTED, BACK OUTLET WITH MANUAL 1.28 GPF FLUSH VALVE

E. COLOR: WHITE

F. TOILET SEAT: COMMERCIAL (HEAVY DUTY), WHITE PLASTIC OPEN FRONT

B. TYPE: VITREOUS CHINA, WHITE

C. NOMINAL SIZE: RECTANGULAR, 20-1/4 BY 15-11/16 INCHES

B. TYPE: STAINLESS STEEL

B. TYPE: STAINLESS STEEL, FLOOR & WALL MOUNT

C. NOMINAL SIZE: 25" X 19-1/2"

E. FAUCET: WALL MOUNT, ROUGH CHROME FINISH, WALL BRACE, VACUUM BREAKER, PAIL HOOK,

B. TYPE: STAINLESS STEEL, BI-LEVEL, BOTTLE FILLER

C. NOMINAL SIZE: APPROX 5.83" WIDE X 6" HIGH

C. SIZE: 3/4" MALE HOSE THREAD

CONNECTIONS:

CONNECT DOMESTIC WATER, WASTE, AND VENT PIPING TO WATER-SERVICE PIPING AS INDICATED,

ESCUTCHEONS AND FLOOR PLATES:

ESCUTCHEONS SHALL BE ONE-PIECE, STEEL TYPE WITH POLISHED, CHROME-PLATED FINISH AND SETSCREW FASTENER.

IDENTIFICATION AND LABELS:

PROVIDE AND INSTALL LABELS ON EQUIPMENT. LABELS SHALL BE BLACK WITH WHITE LETTERING. LABELS SHALL BE CLEARLY READABLE FROM A DISTANCE OF 5 FEET.

PROVIDE AND INSTALL LABELS INDICATING LOCATION AND MARK OF EQUIPMENT LOCATED ABOVE CEILING REQUIRING ROUTINE MAINTENANCE. LABELS SHALL BE WHITE WITH BLACK LETTERING AND

PROVIDE PRE-PRINTED SELF-ADHESIVE PIPE LABELS WITH LABELS INDICATING SERVICE, AND SHOWING FLOW DIRECTION IN ACCORDANCE WITH ASME A13.1.

PIPE SUPPORT:

PROVIDE PIPE SUPPORT IN ACCORDANCE WITH ANSI/MSS SP-58.

METAL RING, AND GRADE A ACCURACY.

THERMOMETERS SHALL BE METAL-CASE, COMPACT-STYLE, LIQUID-IN-GLASS TYPE.

BASIS OF DESIGN: EEMAX MINI TANK SERIES

A. STANDARD: ASME A112.19.2

C. BOWL MATERIAL: VITREOUS CHINA D. HEIGHT: 15 TO 17 INCHES

<u>LAVATORIES (L-1):</u>
A. STANDARD: ASME A112.19.2

D. HEIGHT: CABINET UNDERMOUNT

E. FAUCET: BATTERY POWERED ELECTRONIC, POLISHED CHROME

<u>SINKS (S-1):</u> A. STANDARD: ASME A112.19.3

C. NOMINAL SIZE: 30-1/2" X 18-1/2" X 5-7/8"

D. HEIGHT: CABINET UNDERMOUNT, ADA E. FAUCET: SINGLE HOLE, 3 FUNCTION PULL-DOWN SPRAY HEAD, POLISHED CHROME

<u>SINKS (S-2):</u> A. STANDARD: ASME A112.19.3

D. HEIGHT: 27-3/4"

LEVER HANDLES, AND STOPS.

WATER COOLER (EWC-1): A. STANDARD: ASME A112.19.3

C. NOMINAL SIZE: 36" X 18" D. HEIGHT: 32-15/16" - 39-7/16"

A. STANDARD: ASME A112.18.1 B. TYPE: PLASTIC WITH WATER HAMMER ARRESTOR

D. VALVE: 1/4 TURN

WALL HYDRANT (WH-1)
A. STANDARD: ASSE 1019

B. TYPE: FREEZELESS, ANTI-SIPHON, EXPOSED HANDWHEEL

BUT NOT SMALLER THAN REQUIRED BY EQUIPMENT AND FIXTURES.

INSTALL ESCUTCHEONS FOR PIPING PENETRATIONS OF WALLS, CEILINGS, AND FLOORS.

INSTALL FLOOR PLATES FOR PIPING PENETRATIONS OF EQUIPMENT-ROOM FLOORS. SPLIT FLOOR PLATES SHALL BE OF CAST BRASS WITH CONCEALED HINGE.

SHALL BE CLEARLY READABLE FROM A DISTANCE OF 5 FEET.

ISSUE/REVISION

PROJECT

CLIENT

LEXINGTON

RENOVATION

CITY OF LEXINGTON

300 E. WASHINGTON STREET

10 South Jefferson Street, Suite 1600

540.857.3100 tel 540.857.3180 fax

LEXINGTON, VA 24450

CONSULTANT

Roanoke, Virginia 24011

CONSULTANTS

REGISTRATION

www.aecom.com

540.462.3700 tel

CITY HALL

01/03/2025 FINAL DESIGN SUBMISSION

DESCRIPTION

KEY PLAN

I/R DATE

PROJECT NUMBER

SHEET TITLE

SHEET NUMBER

SCHEDULES

READY FOR CONSTRUCTION

GENERAL NOTES THIS SHEET:

A. SEE SHEET P-001 FOR LEGEND AND GENERAL NOTES.

PROJECT LEXINGTON CITY HALL RENOVATION

CLIENT

CITY OF LEXINGTON

300 E. WASHINGTON STREET LEXINGTON, VA 24450 540.462.3700 tel


CONSULTANT

AECOM

10 South Jefferson Street, Suite 1600
Roanoke, Virginia 24011
540.857.3100 tel 540.857.3180 fax
www.aecom.com

CONSULTANTS

REGISTRATION

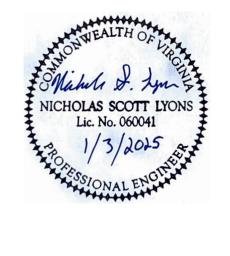

ISSUE/REVISION

KEY PLAN

PROJECT NUMBER

SHEET TITLE

RISER DIAGRAMS

SHEET NUMBER

READY FOR CONSTRUCTION

3/4" CW-\

RISER DIAGRAM