GE	NERAL MECHANICAL & PLUMBING NOTES AND SPECFICIATIONS:	PLUMBIN	G FIXTURE SO
1.	ALL WORK SHALL BE IN ACCORDANCE WITH THE 2018 VIRGINIA UNIFORM STATEWIDE BUILDING CODE, ALL FEDERAL, STATE, AND CITY CODES, ORDINANCES, AND STANDARDS.	WC-1	WATER CL FLUSHOME BOWL, WAI SEAT WITH
2.	IT IS THE INTENT OF THESE DOCUMENTS THAT THE CONTRACTOR PROVIDE ALL LABOR, MATERIAL, EQUIPMENT AND TOOLS FOR THE COMPLETE INSTALLATION OF ALL WORK SHOWN ON THE PLANS AND/OR DESCRIBED HEREIN, INCLUDING ALL DEVISES AND CONTROLS REQUIRED TO PROVIDE A COMPLETE AND FUNCTIONING SYSTEM.		STAINLESS ANTIMICRO EQUAL WIT BE PROVID ADA COMP
-	ALL WORK PROVIDED UNDER THIS CONTRACT INCLUDING ALL MECHANICAL EQUIPMENT, MATERIALS, AND LABOR SHALL BE PROVIDED WITH A 1 YEAR WARRANTY.	L-1	AMERICAN HANDICAP CENTERSE OFFSET P\
-	CONTRACTOR SHALL PROVIDE SHOP DRAWINGS FOR ALL EQUIPMENT FOR APPROVAL PRIOR TO INSTALLATION.		STOPS. PR SUPPLIES
5.	THESE DRAWINGS ARE DIAGRAMMATIC IN NATURE. NOT ALL FITTINGS, OFFSETS, VENTS, OR DRAINS ARE SHOWN. THE CONTRACTOR SHALL INCLUDE ALL OFFSETS, VENTS, AND DRAINS AS REQUIRED FOR A FULLY FUNCTIONING SYSTEM.	L-2	SOLID SUR LK406GN05 SPOUT ANI PERFORAT
5.	ALL DUCTWORK CONSTRUCTION AND INSTALLATION SHALL COMPLY WITH THE LATEST EDITION OF THE SMACNA DUCT CONSTRUCTION HANDBOOK.	SH-1	XXX
	SLOPES AND INVERT ELEVATIONS OF EXISTING SEWER SHALL BE ESTABLISHED AND VERIFIED BY CONTRACTOR BEFORE ANY PIPING IS INSTALLED IN ORDER THAT PROPER SLOPE WILL BE MAINTAINED AND NECESSARY INVERT ELEVATIONS	S-1 S-2	xxx xxx
	OBTAINED.	S-2	XXX
	ALL PIPES SHALL BE COORDINATED WITH OTHER NEW AND EXISTING DUCTS, PIPES, LIGHTS, STRUCTURAL SYSTEM, CEILING SUPPORTS AND FRAMING BEFORE	EWC-1:	ELECTRIC
	INSTALLATION. MINOR PIPE OFFSETS SHALL BE PROVIDED AS REQUIRED. MEASUREMENTS FOR VERTICAL CLEARANCES SHALL BE TAKEN AT THE JOB SITE BEFORE INSTALLATION OF ANY PIPING.		BI-LEVEL C SHALL DEL WATER. PU ELECTRON
9.	PIPING SHALL NOT BE INSTALLED ABOVE ELECTRICAL PANELS. COORDINATE INSTALLATION OF PIPES WITH ELECTRICAL PANELS WHEN SHOWN NEAR PANELS OR OVER ELECTRICAL ROOMS.		20-SECONE AREA, BRIC TICKER™ E FILLER SHA SPLASHINC
SP	RINKLER NOTES:		FILTER, CE WHEN REP FILTER ANI
1.	SPRINKLER CONTRACTOR SHALL MODIFY EXISTING SPRINKLER SYSTEM FOR AREA OF WORK AND PROVIDE THE DESIGN AND INSTALLATION OF THE FIRE SUPPRESSION SYSTEM IN ACCORDANCE WITH NFPA 13 AND THE CURRENT VIRGINIA UNIFORM STATEWIDE BUILDING CODE.		ABILITY TO DIAGNOSIN INTEGRATE MEET ADA
2.	ALL AREAS WITHIN THE RENOVATION ARE CONSIDERED TO HAVE AN OCCUPANCY		TO NSF/AN REQUIREM

- 2. ALL AREAS WITHIN THE RENOVATION ARE CONSIDERED TO HAVE AN OCCUPANCY CLASSIFICATION OF LIGHT HAZARD.
- 3. REMOVE ALL SPRINKLER HEADS AND SPRINKLER BRANCH PIPING NOT REQUIRED FOR NEW LAYOUT.
- 4. PROVIDE NEW QUICK RESPONSE TYPE SPRINKLER HEADS WITHIN THE RENOVATION AREAS. NEW HEADS SHALL BE CENTERED WITHIN THE CEILING GRID TILES WHERE APPLICABLE AND SHALL MATCH THE EXISTING TYPE OF SPRINKLER HEADS CURRENTLY LOCATED WITHIN THE EXISTING FACILITY. THE SPRINKLER CONTRACTOR SHALL BE RESPONSIBLE TO COORDINATE WITH THE OWNERS DESIGN STANDARDS FOR THE FACILITY.
- 5. HYDRAULIC CALCULATIONS SHALL BE PERFORMED AS NECESSARY TO MEET SPECIFIC DEMAND FOR THE RENOVATED AREAS.

SCHEDULE:

LOSET: AMERICAN STANDARD "AFWALL MILLENNIUM FLOWISE ELONGATED IETER TOILET" MODEL #3352.101, VITREOUS CHINA ELONGATED SIPHON JET ALL MOUNTED, WHITE EXTRA HEAVY DUTY SOLID PLASTIC OPEN FRONT HOUT COVER, TOP SPUD WITH SLOTTED RIM FOR BEDPAN HOLDING, SS STEEL CHECK HINGE, ADA COMPLIANT. PERMANENT EVERCLEAN ROBIAL SURFACE. FLUSH VALVE SHALL BE MOEN 8310M128 SERIES OR ITH BED PAN WASHER MODEL 8310BPW16 (BED PAN WASHER SHALL ONLY IDED FOR PATIENT ROOMS), 1.28 GPF CHROME PISTON FLUSH VALVE WITH IPLIANT HANDLE. PROVIDE WITH NEW WATER CLOSET CARRIER IN WALL.

N STANDARD "LUCERNE" 0355.012 WHITE VITREOUS CHINA WALL HUNG P LAVATORY, THREE HOLE MOUNT FOR 4" CENTERS, WITH MOEN 8413F05 SET CHROME FAUCET WITH SINGLE LEVER HANDLE, METAL GRID STRAINER, PVC P-TRAP, FLEXIBLE TUBING SUPPLIES, COMPRESSION FITTINGS AND ROVIDE TRUEBRO #102W PRE- MOLDED INSULATION ON BOTH WATER S AND DRAIN. PROVIDE WITH WALL CARRIER.

IRFACE COUNTER WITH INTEGRAL SINK. PROVIDE ELKAY FAUCET MODEL 05T4, 4" CENTERSET WITH EXPOSED DECK FAUCET WITH 5" GOOSENECK ND 4" WRISTBLADE HANDLES IN CHROME. PROVIDE DRAIN WITH ATED GRID STRAINER AND TAILPIECE.

WATER COOLER, ELKAY EZH20 BOTTLE FILLER STATION WITH FILTERED COOLER. MODEL LZSTL8WS(VR)SP WITH HI/LO CONFIGURATION. UNIT ELIVER 8 GPH OF 50°F OF DRINKING WATER AT 90°F AMBIENT AND 80°F INLET PUSH BAR ACTIVATION. BOTTLE FILLING UNITS SHALL INCLUDE AN NIC SENSOR FOR TOUCHLESS ACTIVATION WITH AN AUTOMATIC ND SHUT-OFF TIMER. LED LIGHT ILLUMINATING THE WATER DISPENSING RIGHTENING AS WATER IS BEING DISPENSED. SHALL INCLUDE A GREEN DISPLAYING COUNT OF PLASTIC BOTTLES SAVED FROM WASTE. BOTTLE HALL PROVIDE A 1.1 GPM FLOW RATE WITH LAMINAR FLOW TO MINIMIZE NG. SHALL INCLUDE THE WATERSENTRY® PLUS 3000-GALLON CAPACITY CERTIFIED TO NSF/ANSI 42 & 53, WITH VISUAL FILTER MONITOR TO INDICATE PLACEMENT IS NECESSARY. UNIT SHALL AUTOMATICALLY DETECT A NEW ND RESET VISUAL FILTER MONITOR ACCORDINGLY. UNIT SHALL HAVE THE TO TURN OFF REFRIGERATION SYSTEM AS NEEDED, IN ADDITION TO SELF ING SYSTEM ISSUES AND DISPLAY RELATED MESSAGES. SHALL INCLUDE TED SILVER ION ANTI-MICROBIAL PROTECTION IN KEY AREAS. UNIT SHALL A GUIDELINES. UNIT SHALL BE A LEAD-FREE DESIGN WHICH IS CERTIFIED NSI 61 AND 372 AND MEETS FEDERAL AND STATE LOW-LEAD REQUIREMENTS.

	LEGEND
 	BRANCH CONNECTION - BOTTOM OF MAIN BRANCH CONNECTION - SIDE OF MAIN BRANCH CONNECTION - TOP OF MAIN
с о	PIPE DOWN OR PIPE FROM BELOW PIPE UP OR PIPE FROM ABOVE
	DIRECTION OF FLOW DOMESTIC COLD WATER DOMESTIC HOT WATER
G	DOMESTIC HOT WATER RECIRCULATING NATURAL GAS PIPING SANITARY SEWER, GREASE WASTE OR DRAIN
	SANITARY VENT CLEANOUT FLUSH WITH FLOOR OUTLET WITH P-TRAP
↔ -+ ₩H	WALL HYDRANT
O	WATER HAMMER ARRESTER
—————————————————————————————————————	GATE VALVE BALL VALVE
	SHUTOFF VALVE IN VERTICAL CHECK VALVE
B	T&P RELIEF VALVE
&	BALANCING COCK
	UNION PRESSURE GAUGE AND GAUGE COCK THERMOMETER
≻' R)	STRAINER, STRAINER WITH DRAIN
Ŷ	RELIEF VALVE
<u> </u>	BACKFLOW PREVENTER (BFP)
0	MEDICAL GAS PIPING - OXYGEN
V	MEDICAL GAS PIPING - VACUUM
———— A ————	MEDICAL GAS PIPING - MEDICAL AIR

PLUMBING EQUIPMENT SCHEDULE:

FD	FLOOR DRAIN, ZURN MODEL Z415, DURA-COATED OUTLET, COMBINATION INVERTIBLE MEMBRANE C WITH SEEPAGE SLOTS.
	FOR MECHANICAL ROOM DRAINS NOT RECIEVING SPACES INCLUDING TOILET, SHOWER, LOCKER RO ROUND, POLISHED NICKEL BRONZE, LIGHT DUTY H
	FOR ANY FLOOR DRAINS RECIEVING INDIRECT WA SINKS), PROVIDE TYPE I POLISHED NICKEL BRONZ
	ALL FLOOR DRAINS SHALL BE PROTECTED AGAINS EVAPORATION BY INSTALLATION OF ELASTOMERIC EQUAL TO PROSET SYSTEMS MODEL #TG.
WHA	JOSAM #75000 SERIES WATER HAMMER ARRESTE ACCORDANCE WITH P.D.I STD WH-201. STAINLESS BELLOWS TYPE, FACTORY PRE-CHARGED WITH TH
HB	HOSE BIBB/ WALL FAUCET. ZURN MODEL Z1341-BI FAUCET FOR USE IN MODERATE CLIMATE INSTALL EXTERNAL BACKFLOW PREVENTER, ALL BRONZE VANDAL-RESISTANT OPERATING STEM, ROUGH BI HOSE CONNECTION (CONFORM TO ASME B1.20.7).
BFP-1	REDUCED PRESSURE ZONE BACK FLOW PREVENT SIZES 2-1/2" - 4": WATTS SERIES 909. PROVIDE WI RESILLIENT SEATED GATE VALVES AND AIR GAP D FLOOR DRAIN.
EX	EXPANSION TANK - AMTROL THERM-X-TROL MODE TANK, 2.0 GALLONS MIN. ACCEPTANCE VOLUME W PRE-CHARGED TO 40 PSI, SET EQUAL TO LINE PRE
GWH-1	GAS WATER HEATER, A.O. SMITH MODEL #BTH-199 235 GAL./HR. RECOVERY AT 40 DEG.F. ENT.AND 10 RELIEF VALVE. PIPING CONNECTIONS INCLUDING EQUIPMENT. WATER HEATER SHALL BE PROVIDED TRAP.
HWCP-1	HOT WATER RE-CIRCULATION PUMP.
TV	WATTS MODEL SERIES LFUSG-B-M2 UNDER SINK O THERMOSTATIC TEMPERING VALVE FOR SINGLE F FOR MAXIMUM 109 DEG. F.
СО	JOSAM CLEANOUT
WCO	WALL CLEANOUT - CHROME FLUSH WALL PLATE, F
FCO	FLOOR CLEANOUT (FINISHED) - RECESSED SATIN FINISH MATERIAL (CARPET/TILE), RECESSED PLUG

IFGEND

	BREVIATIONS
AAV ABV	
AFF	
BFF	BELOW FINISHED FLOOR
	BRITISH THERMAL UNIT
BEL	
CLO	
00	CLEANOUT NN CONNECT, CONNECTION
CW	,
	T CONTINUED
DN	DOWN
EA	
	V ELEVATION
EW(
F FD	
FIN	
FLR	-
FR	FROM
FT	
GPH	
GPN	
GW HB	
НС	HANDICAPPED ACCESSIBLE
HW	
HP	
IN	INCH, INCHES
INV	INVERT
MAX	
MB	
MIN SH	MINIMUM SHEET
TYP	-
V	SANITARY VENT
VTF	VENT THRU ROOF
W	SANITARY WASTE
WC	
WH WH	
ZVE	
	TO EXISTING
	TO EXISTING

CAST IRON BODY WITH BOTTOM CLAMP AND ADJUSTABLE COLLAR

INDIRECT WASTE, FINISHED ROOMS, ETC., PROVIDE WITH TYPE B, HEEL PROOF STRAINER.

ASTE OR CONDESATE (NOT FLOOR ZE STRAINER WITH RAISED FLANGE.

NST LOSS OF TRAP SEAL BY RIC TRAP GUARD DRAIN INSERT,

ER, SIZE AND LOCATION IN SS STEEL SHELL, ELASTOMER THREADED PLUG.

BFP, EXPOSED, ANTI-SIPHON, WALL LATION, COMPLETE WITH Z1399-BFP ZE INTERIOR COMPONENTS, BRONZE EXTERIOR AND 3/4 MALE).

NTER (FOR BUILDING SERVICE) VITH OUTSIDE STEM AND YOKE DRAIN OUTLET PIPED TO NEAREST

DEL #ST-5 THERMAL EXPANSION WITH DIAPHRAGM. FACTORY RESSURE.

99A , 100 GALLON CAPACITY TANK, 100 DEG.F. RISE, 208V/1PH; T & P G T&P RELIEF VALVE ON SIDE OF ED WITH FACTORY INSTALLED HEAT

GUARDIAN ASSE 1080 FIXTURE APPLICATIONS. SET VALVE

RECESSED PLUG.

BRONZE TOP TO RECEIVE FLOOR

	CODE COMPLIANCE						
1.	GOVERNING CODES & REGULATIONS	2021 VIRGINIA CONSTRUCTION CODE (IBC 2021 AMENDED)					
	REGULATIONS	2021 VIRGINIA EXISTING BUILDING CODE (IEBC 2021 AMENDED)					
		2021 VIRGINIA MECHANICAL CODE (IMC 2021 AMENDED)					
		2020 VIRGINIA ELECTRICAL CODE (NFPA 70, 2020 AMENDED)					
		2021 VIRGINIA PLUMBING CODE (IPC 2021 AMENDED)					
		2021 VIRGINIA FUEL GAS CODE (IFGC 2021 AMENDED)					
		2021 VIRGINIA ENERGY CONSERVATION CODE					

	DRAWING INDEX
DRAWING NUMBER	DRAWING TITLE
P001	PLUMBING OVERVIEW SHEET
P100	PLUMBING FIRST FLOOR PLAN - WATER & GAS
P101	PLUMBING SECOND FLOOR PLAN - WATER & GAS
P200	PLUMBING FIRST FLOOR PLAN - WASTE & VENT
P201	PLUMBING SECOND FLOOR PLAN - WASTE & VENT
P300	PLUMBING ROOF PLAN
P400	PLUMBING DETAILS
P500	PLUMBING SPECIFICATIONS

PLUMBING OVERVIEW SHEET DATE: Isue Date PLUMBING OVERVIEW SHEET COM No: 23-30 DRAWN BY: JNB CHECKED BY: JNB Blacksburg, VA STATE PROJECT No:	VIEW SHEET DRAWN BY: CHECKED BY: RV RV STATE PROJEC	LITER AREA PROGRESS SET 09/03/2024 PROGRESS SET 09/03/2024 COMM No: CONSTRUCTION NO: CONSTRUCTION CONSTR	LINC COMMUNICATION OF COMMUNICATION OF COMMUNICATION OF CONTRACT O	DATE PATE DATE PROBINO COMM NO COMM NO STATE PRODEC OBANNA NO COMM NO COMM NO STATE PRODEC OBANNA NO COMM NO COMM
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	NANO BNIRMULA PROGRESS SET	S Design, LLC 20 Midway Plaza Dr Suite 300 Christiansburg, VA 24073 540-230-2619	A S Design, LLC 20 Midway Plaza Dr Suite 300 Christiansburg, VA 24073 540-230-2619 www.5designarchitecture.com	A No MS
	SET	SET 09/03/2024 ACTOR NOTRON SOUTHING Southing Southing Suite 300 Christiansburg, VA 24073 540-230-2619	SET 09/03/2024 Action of Forthow of Faultion of Superior	SET 09/03/2024 Workshuchow Workshuchow Cowstraution Solowie Station Solowie Station Suite 300 Christiansburg, VA 24073 540-230-2619 www.5designarchitecture.com

P001

SHEET



www.stottsbergeng.com 540-216-0331 Project #-----






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	DATE: Issue Date	COMM No: 23-30	DRAWN BY: JNB	CHECKED BY: JNB	STATE PROJECT No:
		PLUMBING FIRST FLOOR PLAN -	GAS		Blacksburg, VA
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	20 N Suit Chri 540	-230- /.5des	ay Pl) sburg 2619	aza [g, VA)	Dr A 24073 ture.com
E N G I N E E R I N G	REVISIONS				
www.stottsbergeng.com 540-216-0331 Project #	SHE		210	0	



1 PLUMBING SECOND FLOOR PLAN - WATER & GAS P101 SCALE = 1/8"=1'-0"

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Dr A 24073 ture.com		ISNRV Blacksburg, VA	STATE PROJECT No:

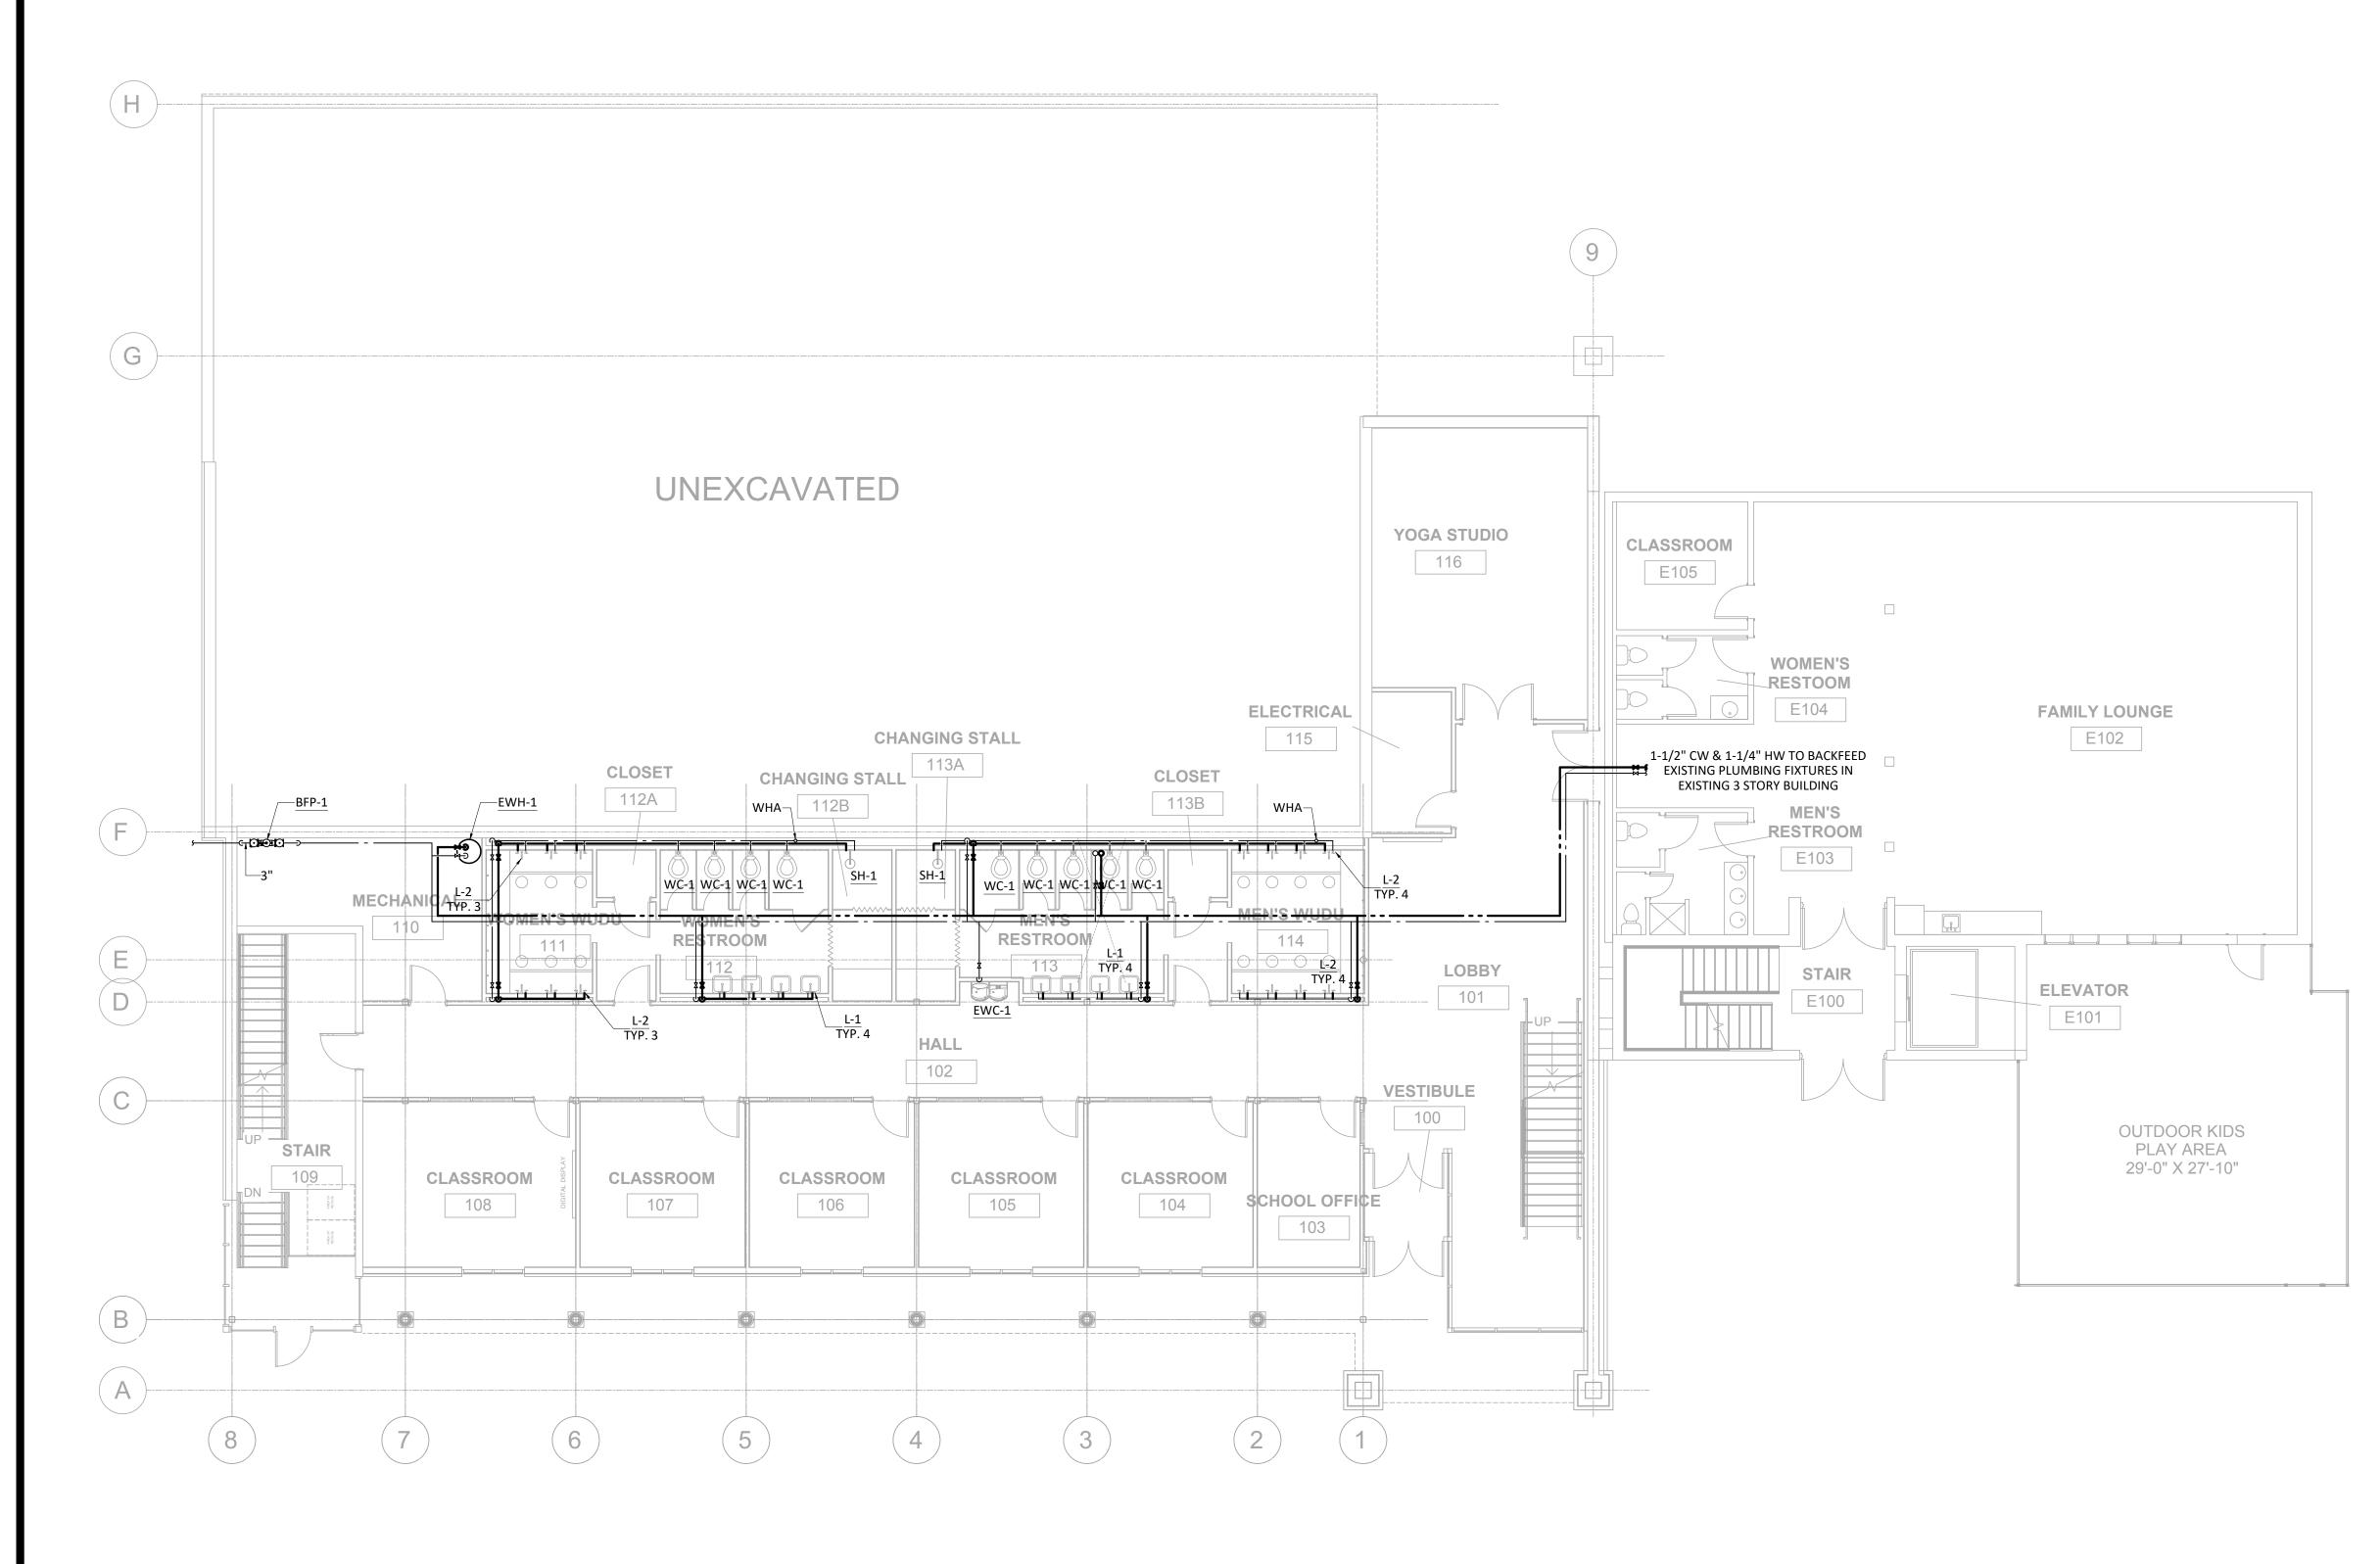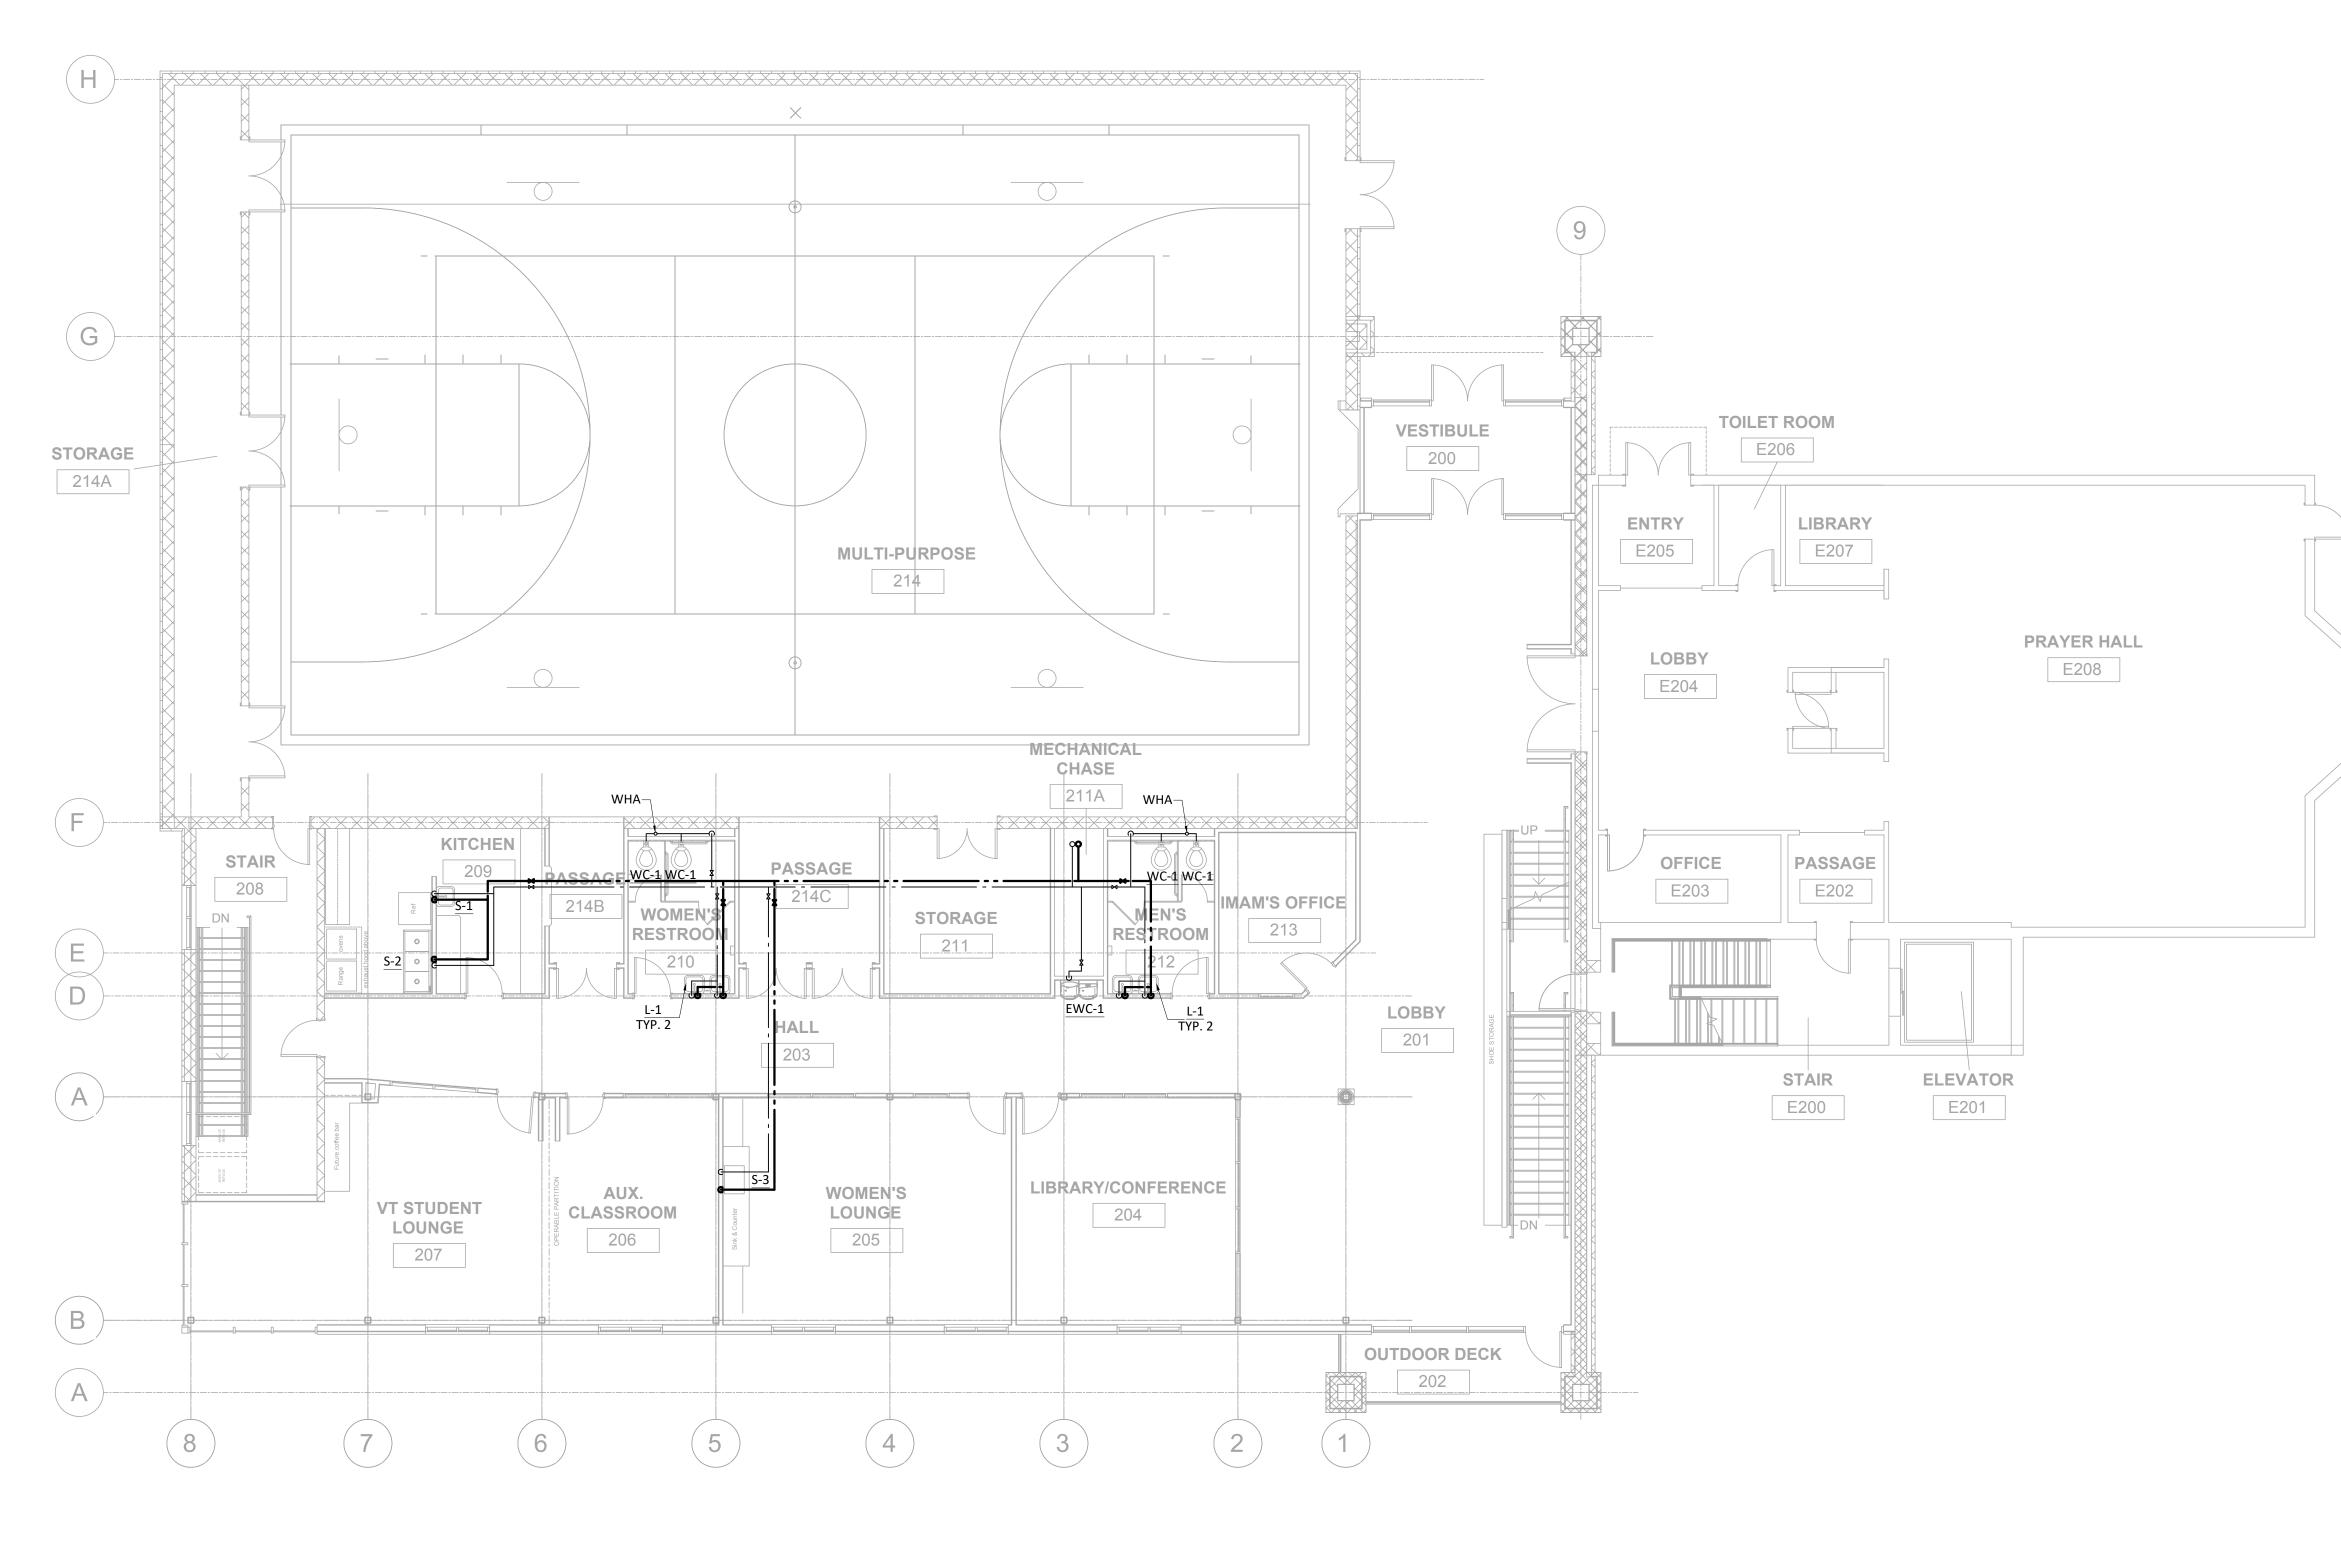

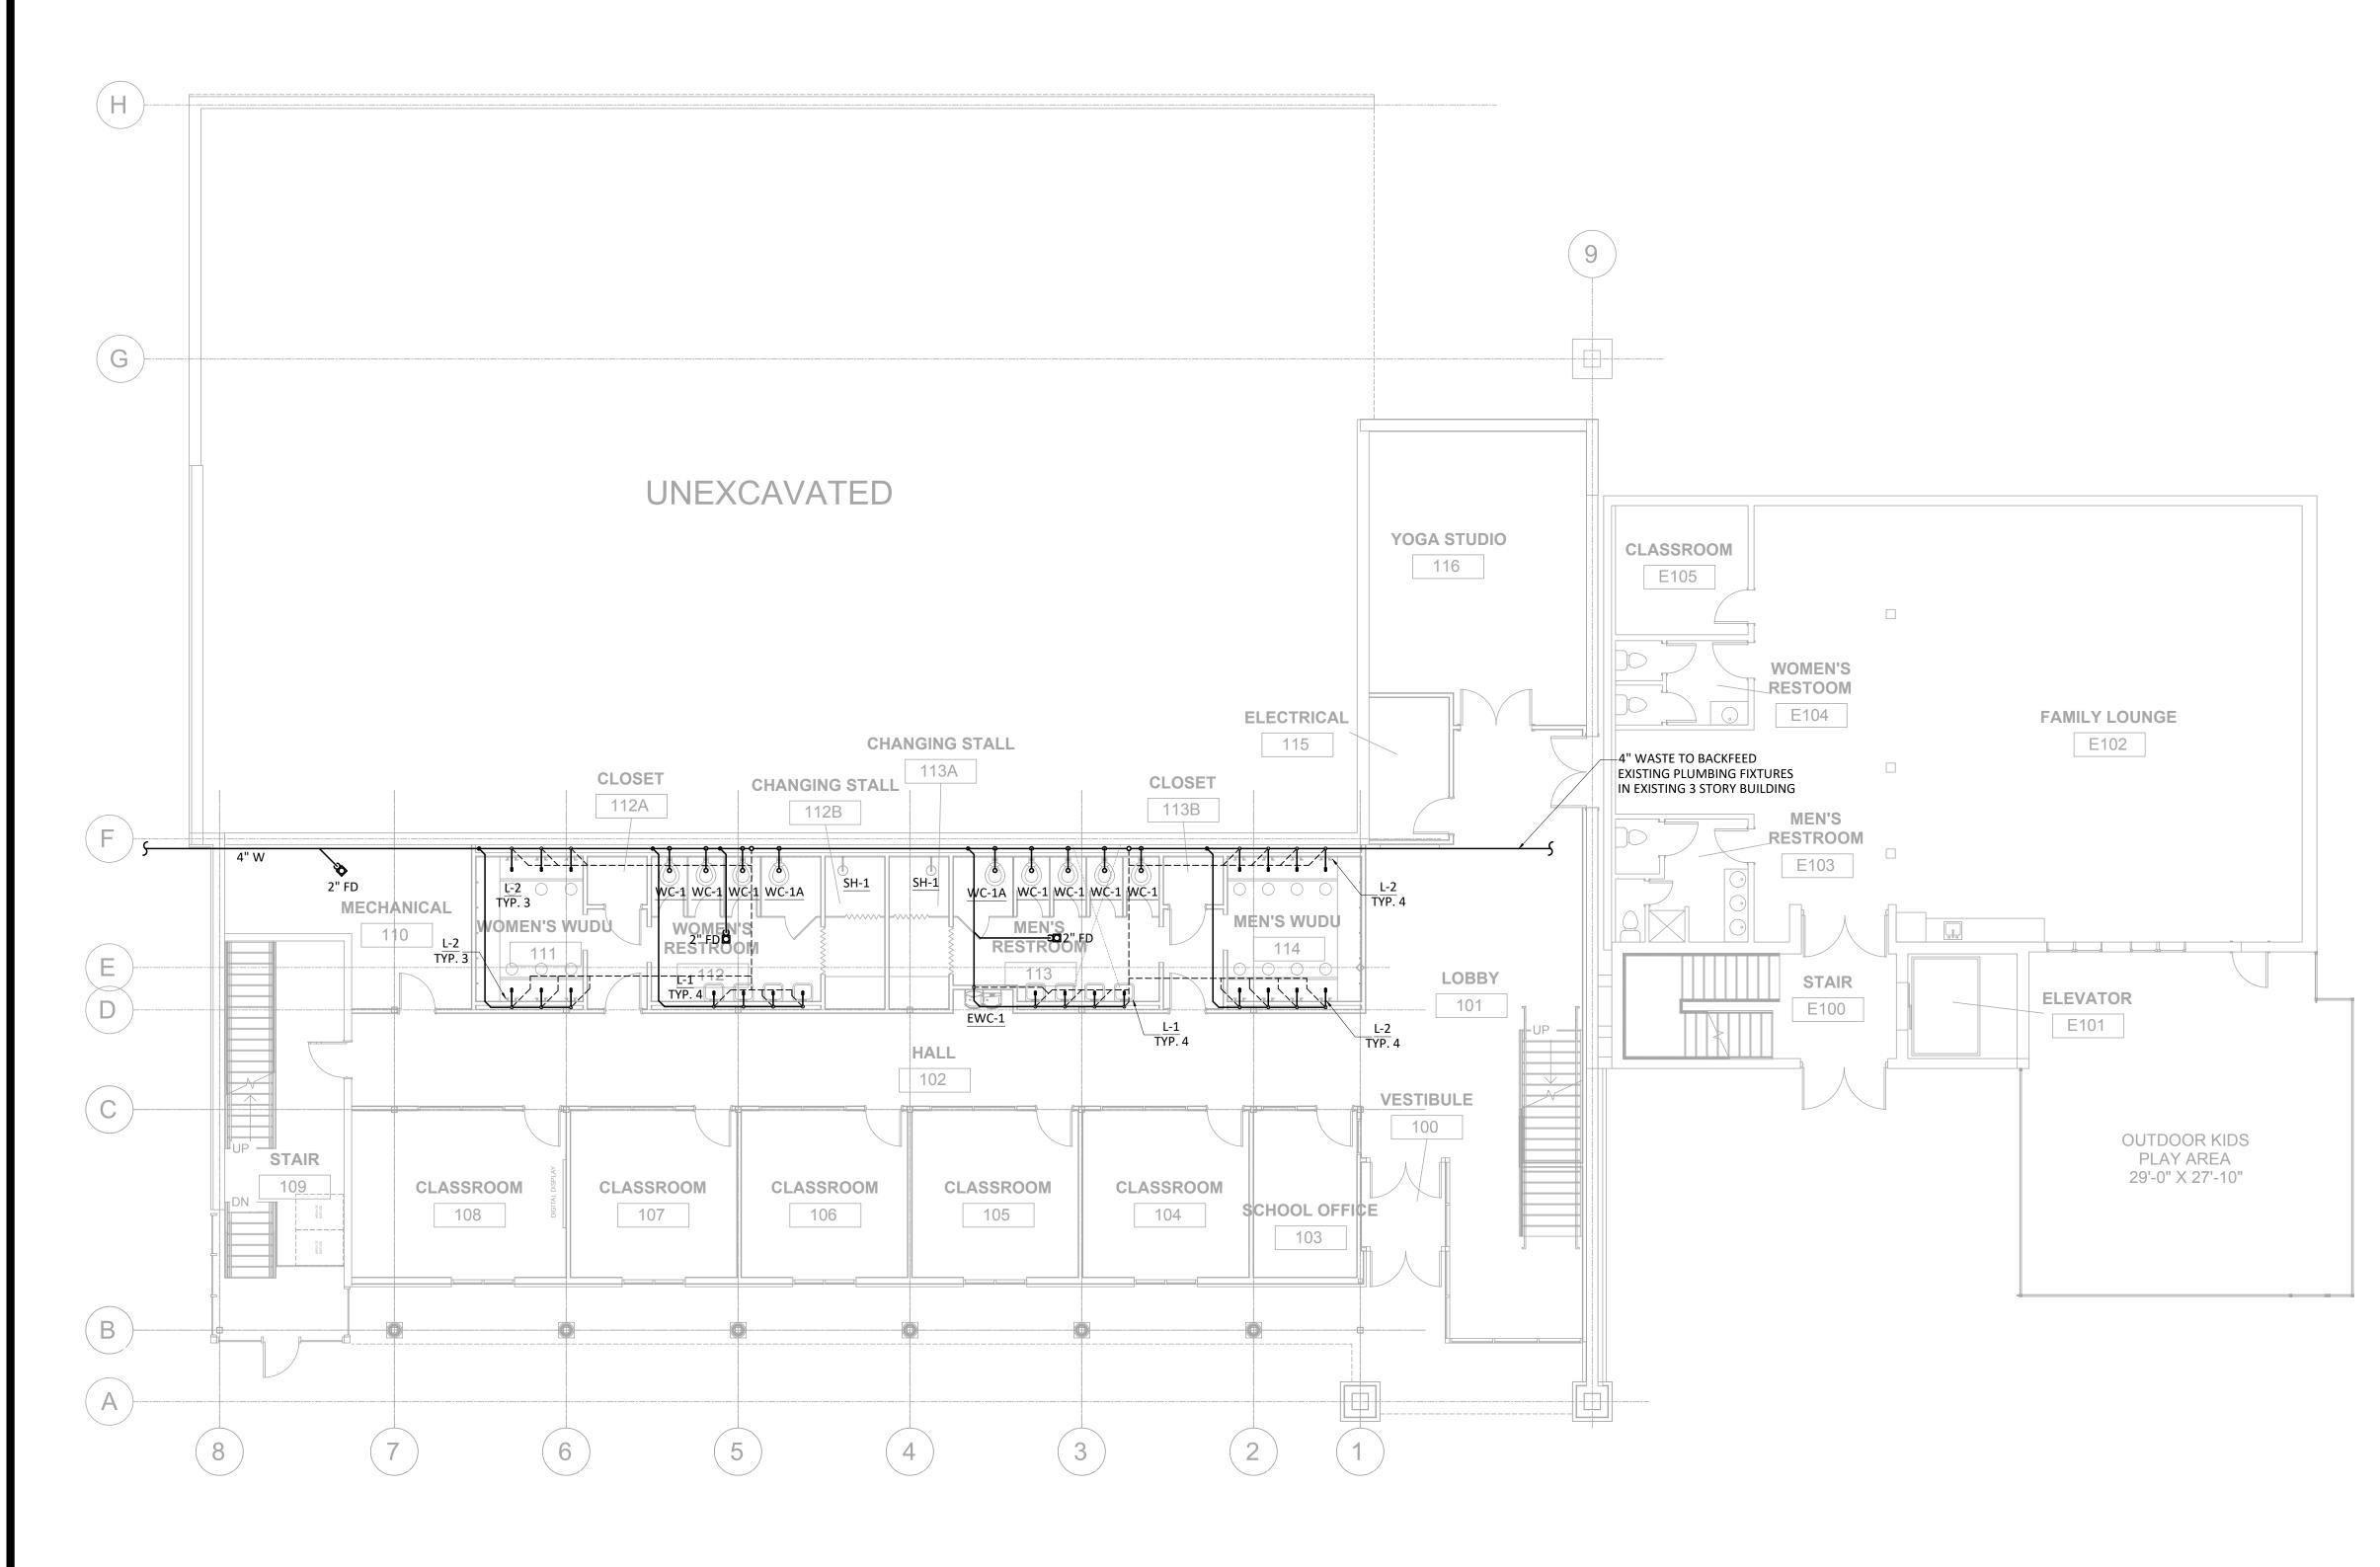 1
 PLUMBING FIRST FLOOR PLAN - WASTE & VENT

 P100
 SCALE = 1/8"=1'-0"

	DATE:Issue DateCOMM No:23-30DRAWN BY:JNBCHECKED BY:JNBSTATE PROJECT No:
	PLUMBING FIRST FLOOR PLAN - WATER & GAS WATER & GAS ISNRV Blackbug, VA
	PROGRESS SET09/03/2024Workpurch Workpurch Workstructure
	5 Design, LLC 20 Midway Plaza Dr Suite 300 Christiansburg, VA 24073 540-230-2619 www.5designarchitecture.com
	DESCRIPTION
STOTTSBERG ENGINEERING www.stottsbergeng.com 540-216-0331 Project #	ਤੰ P200 SHEET







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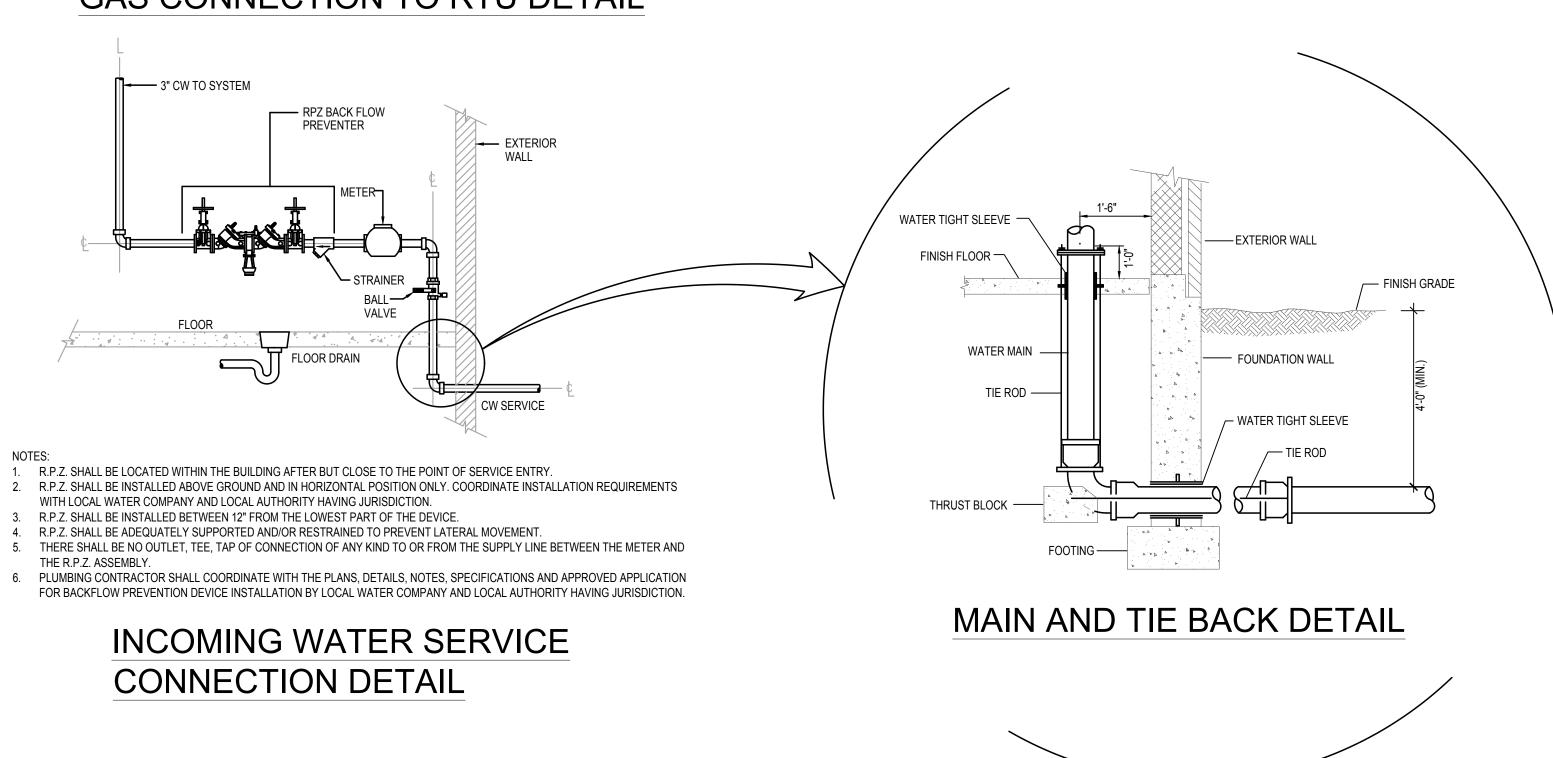


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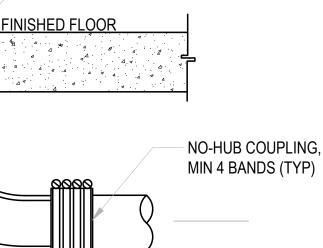




GAS CONNECTION TO RTU DETAIL

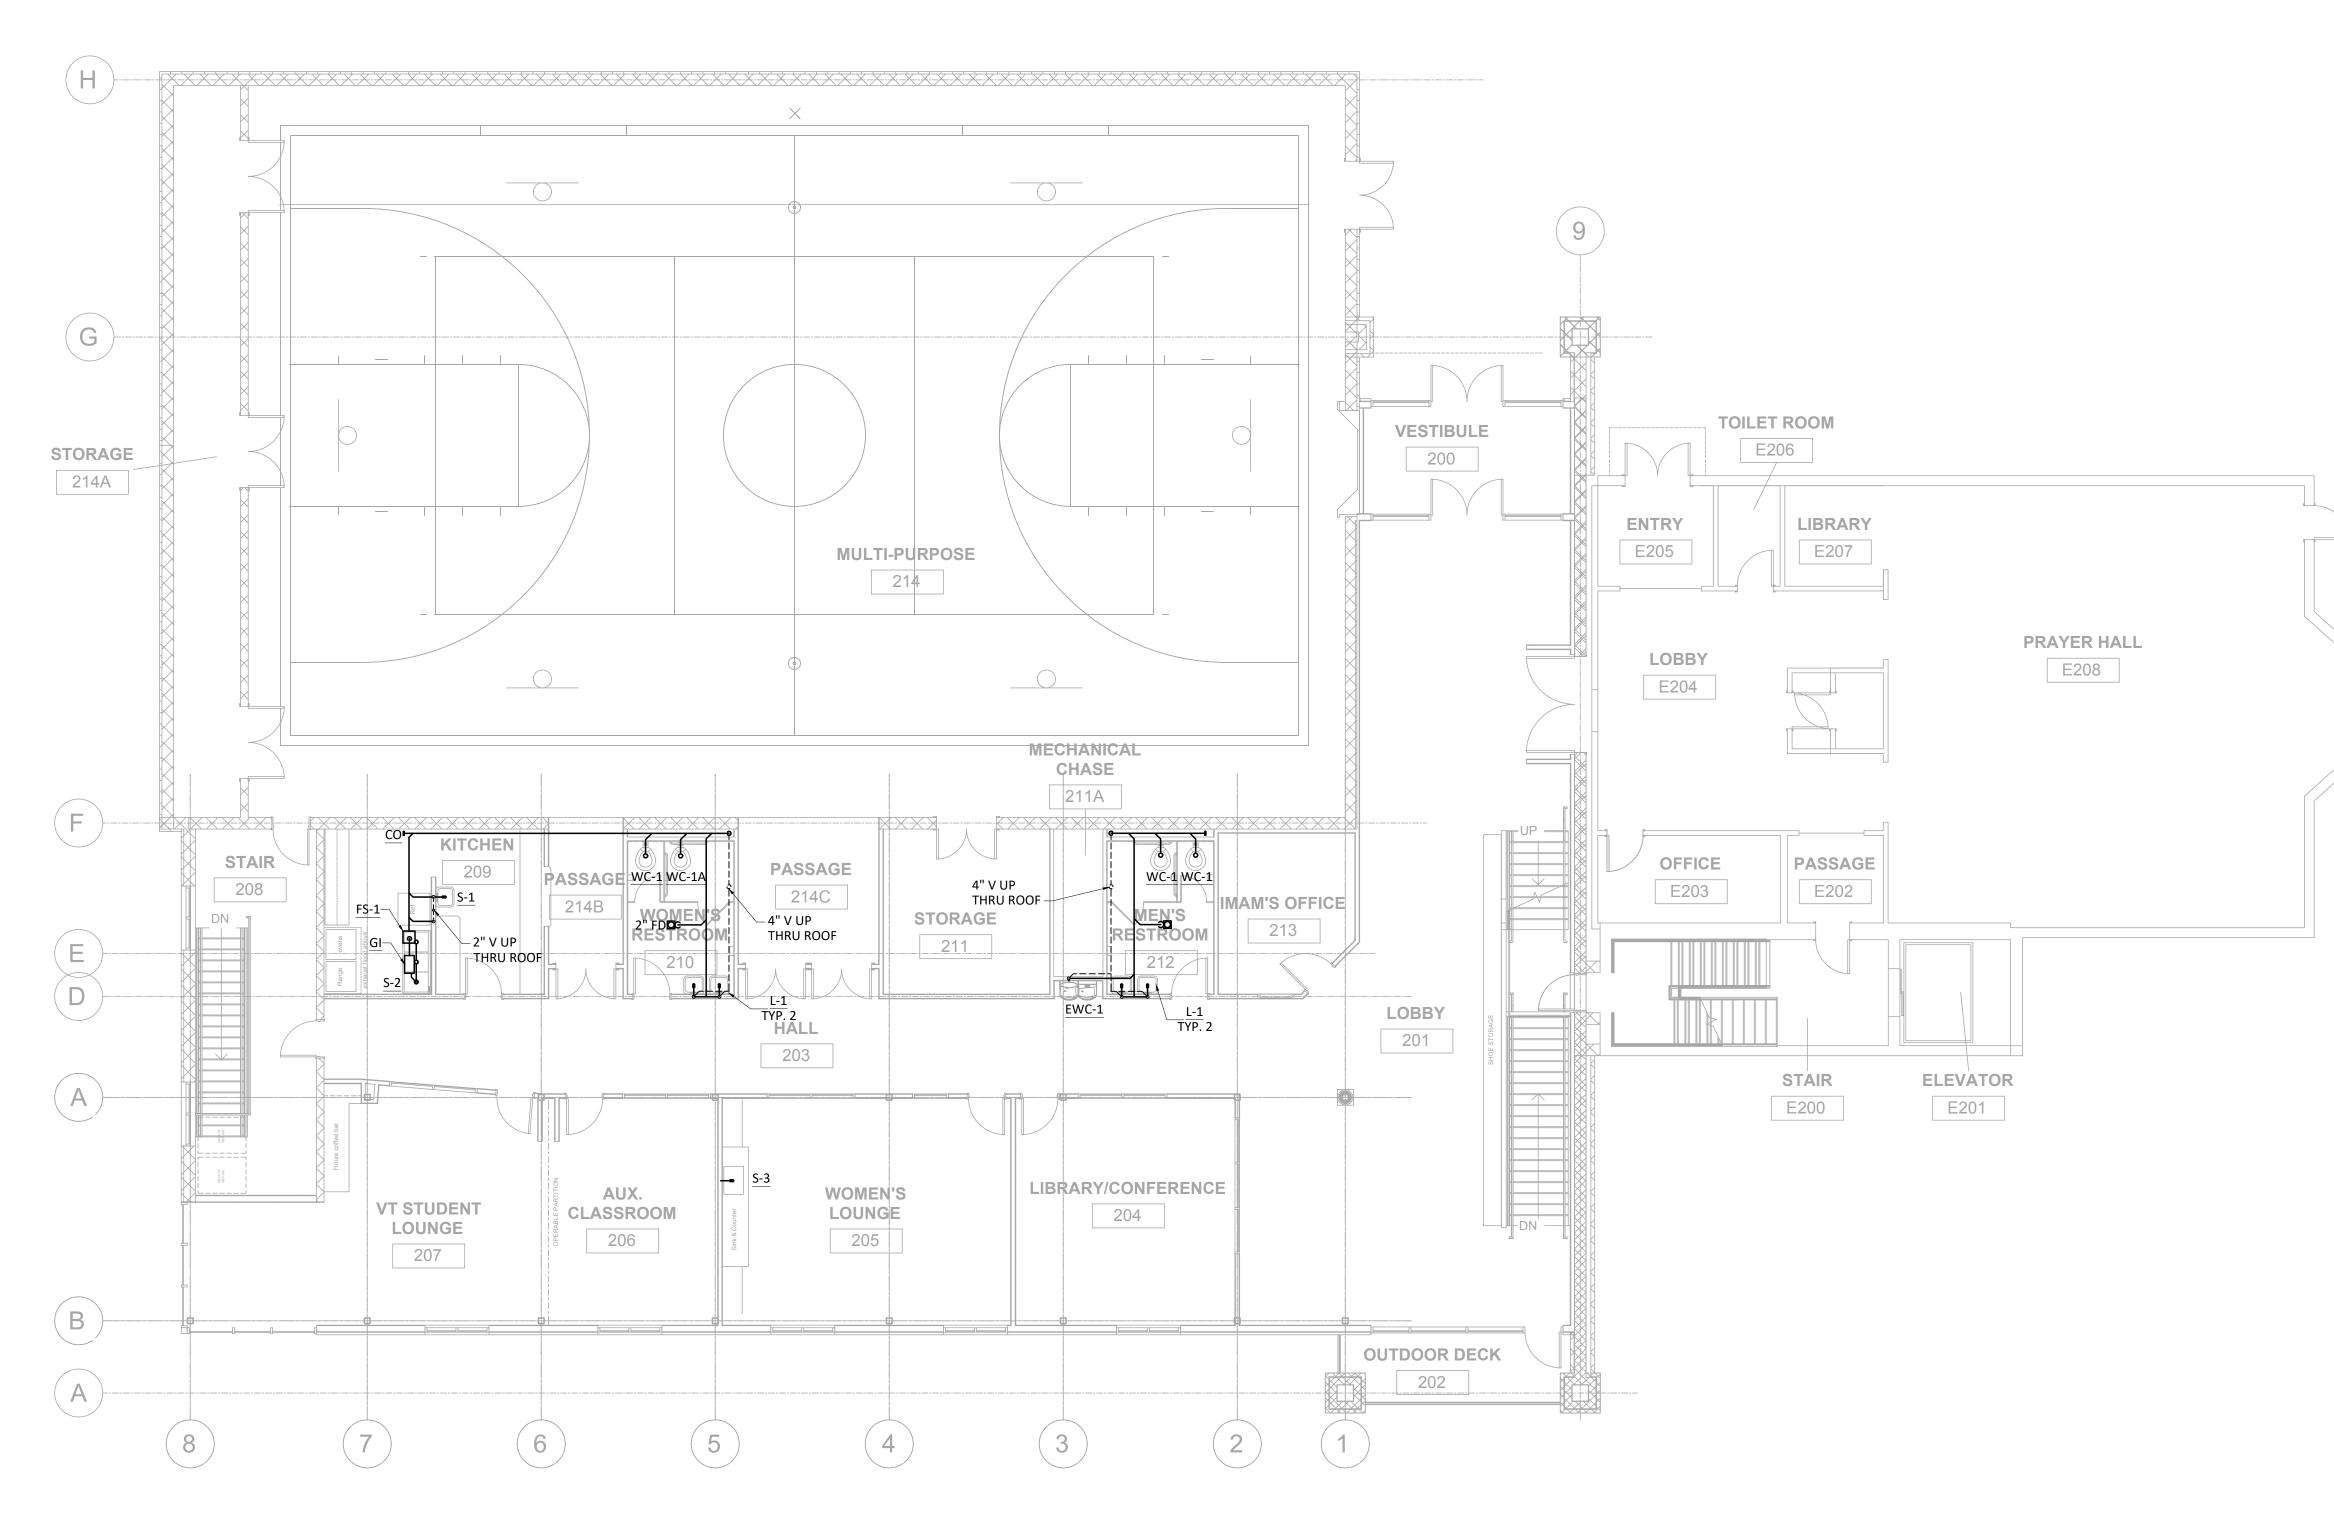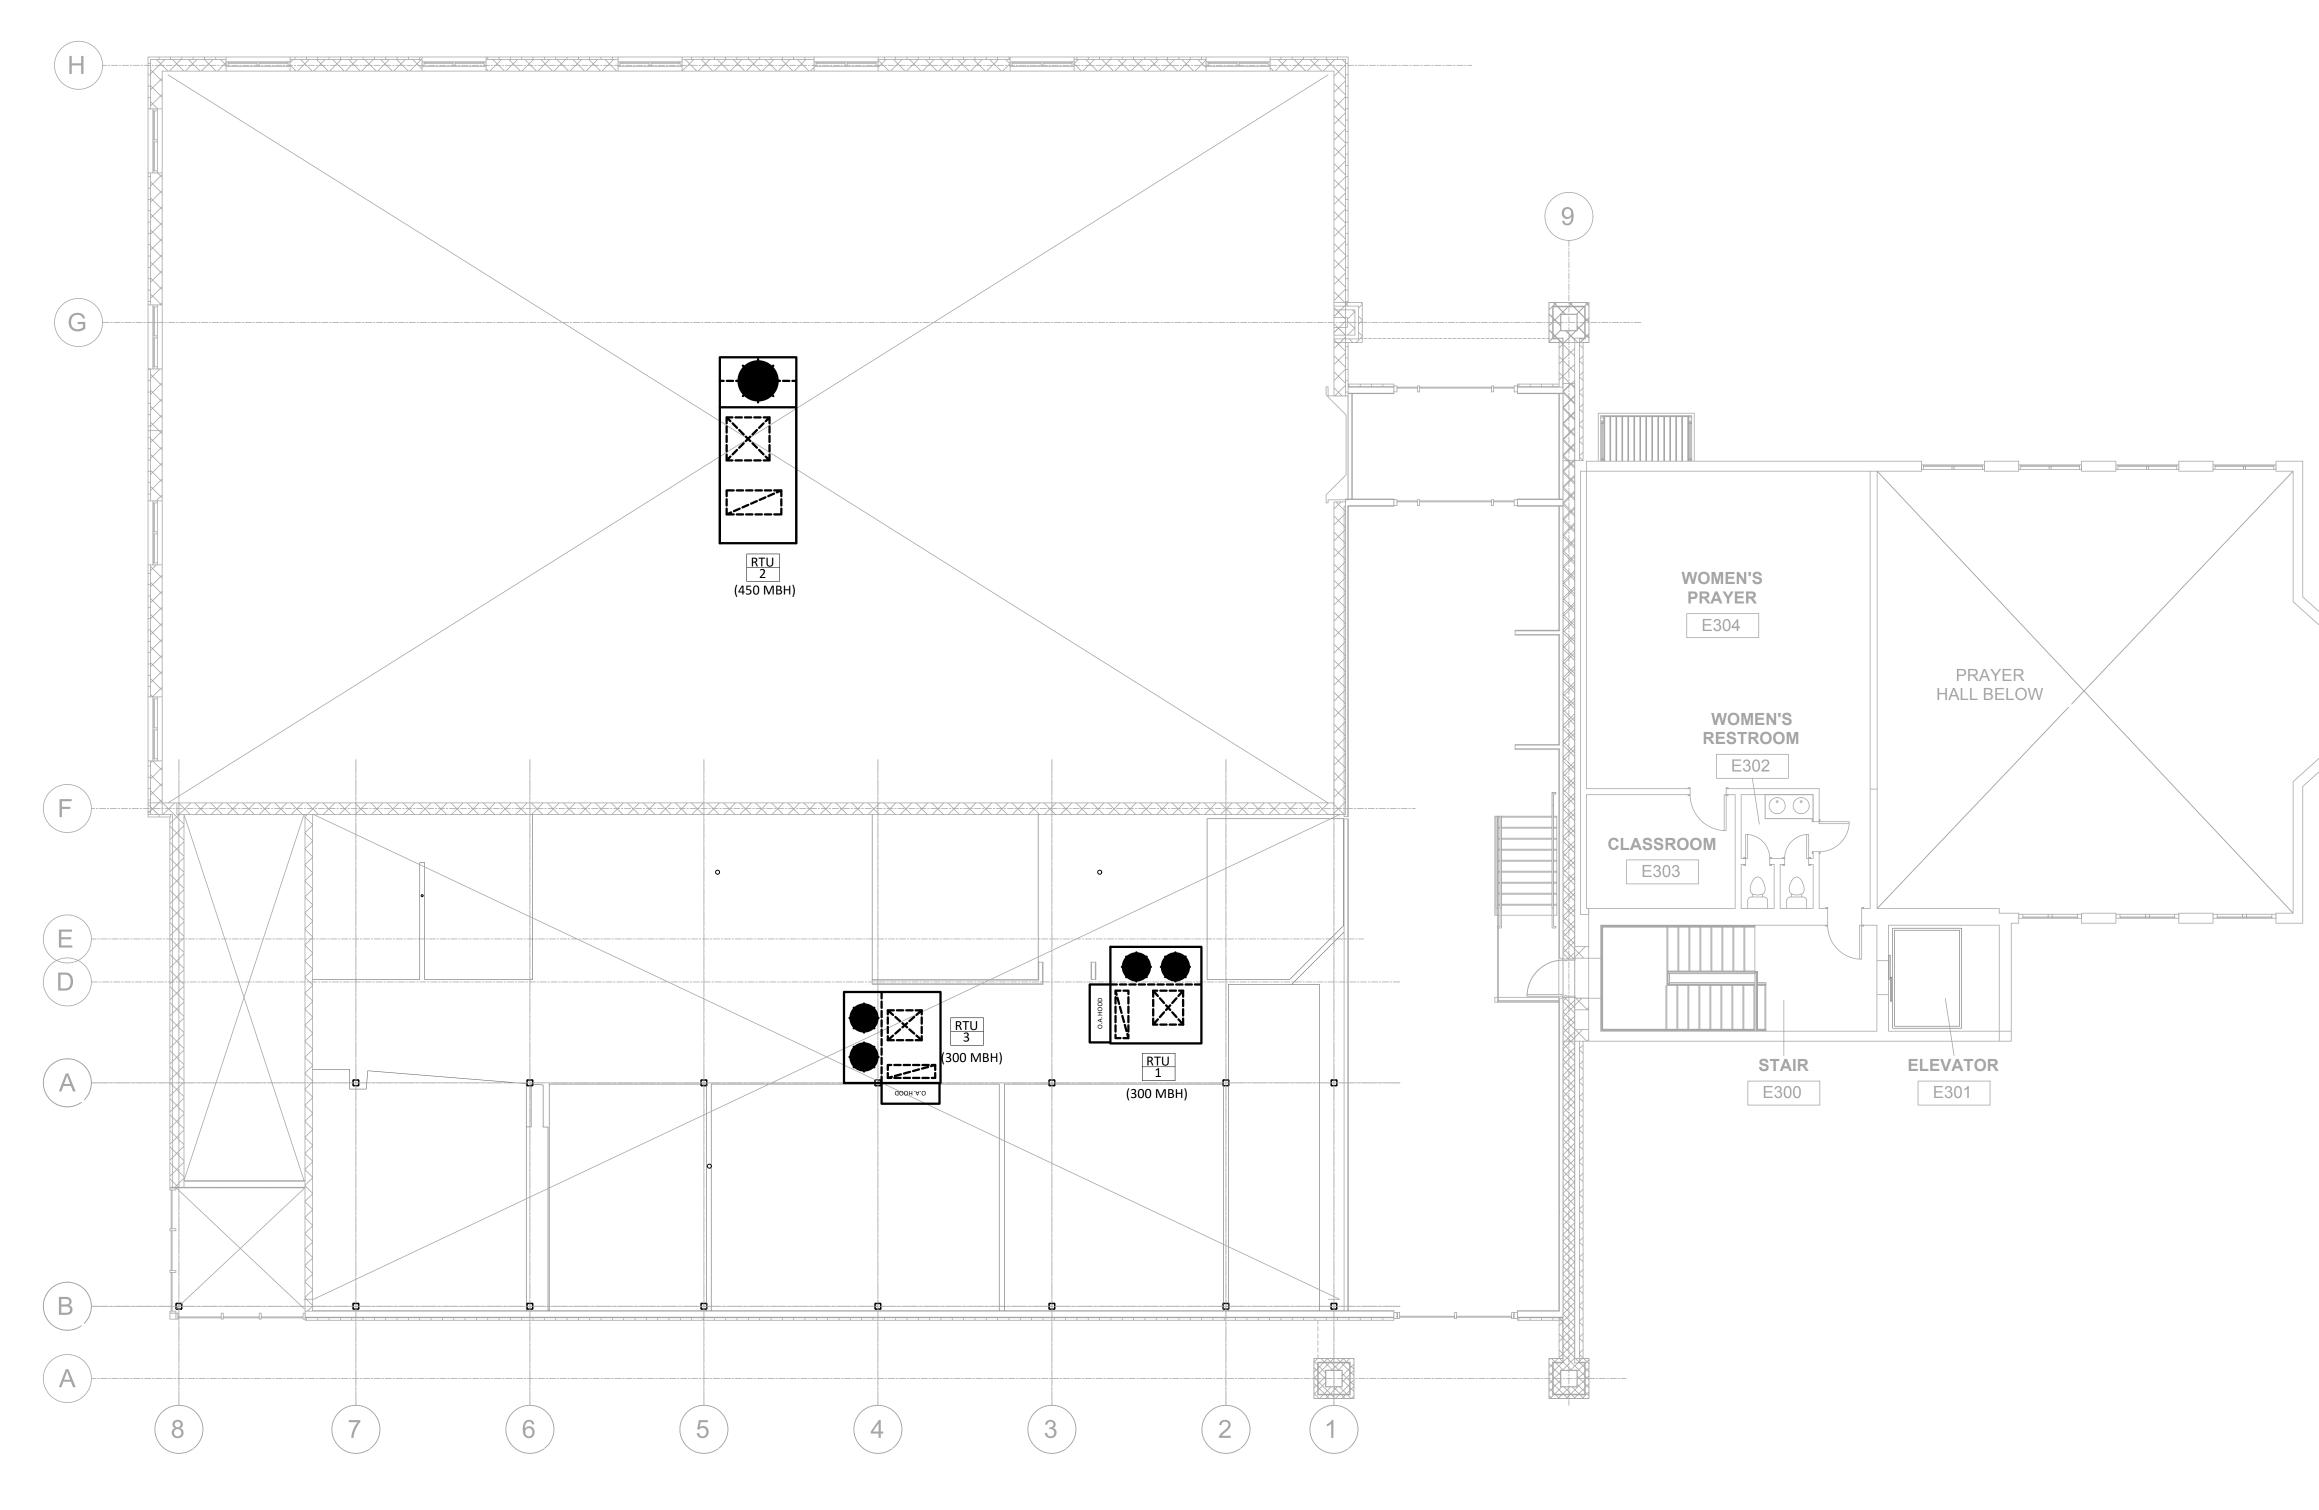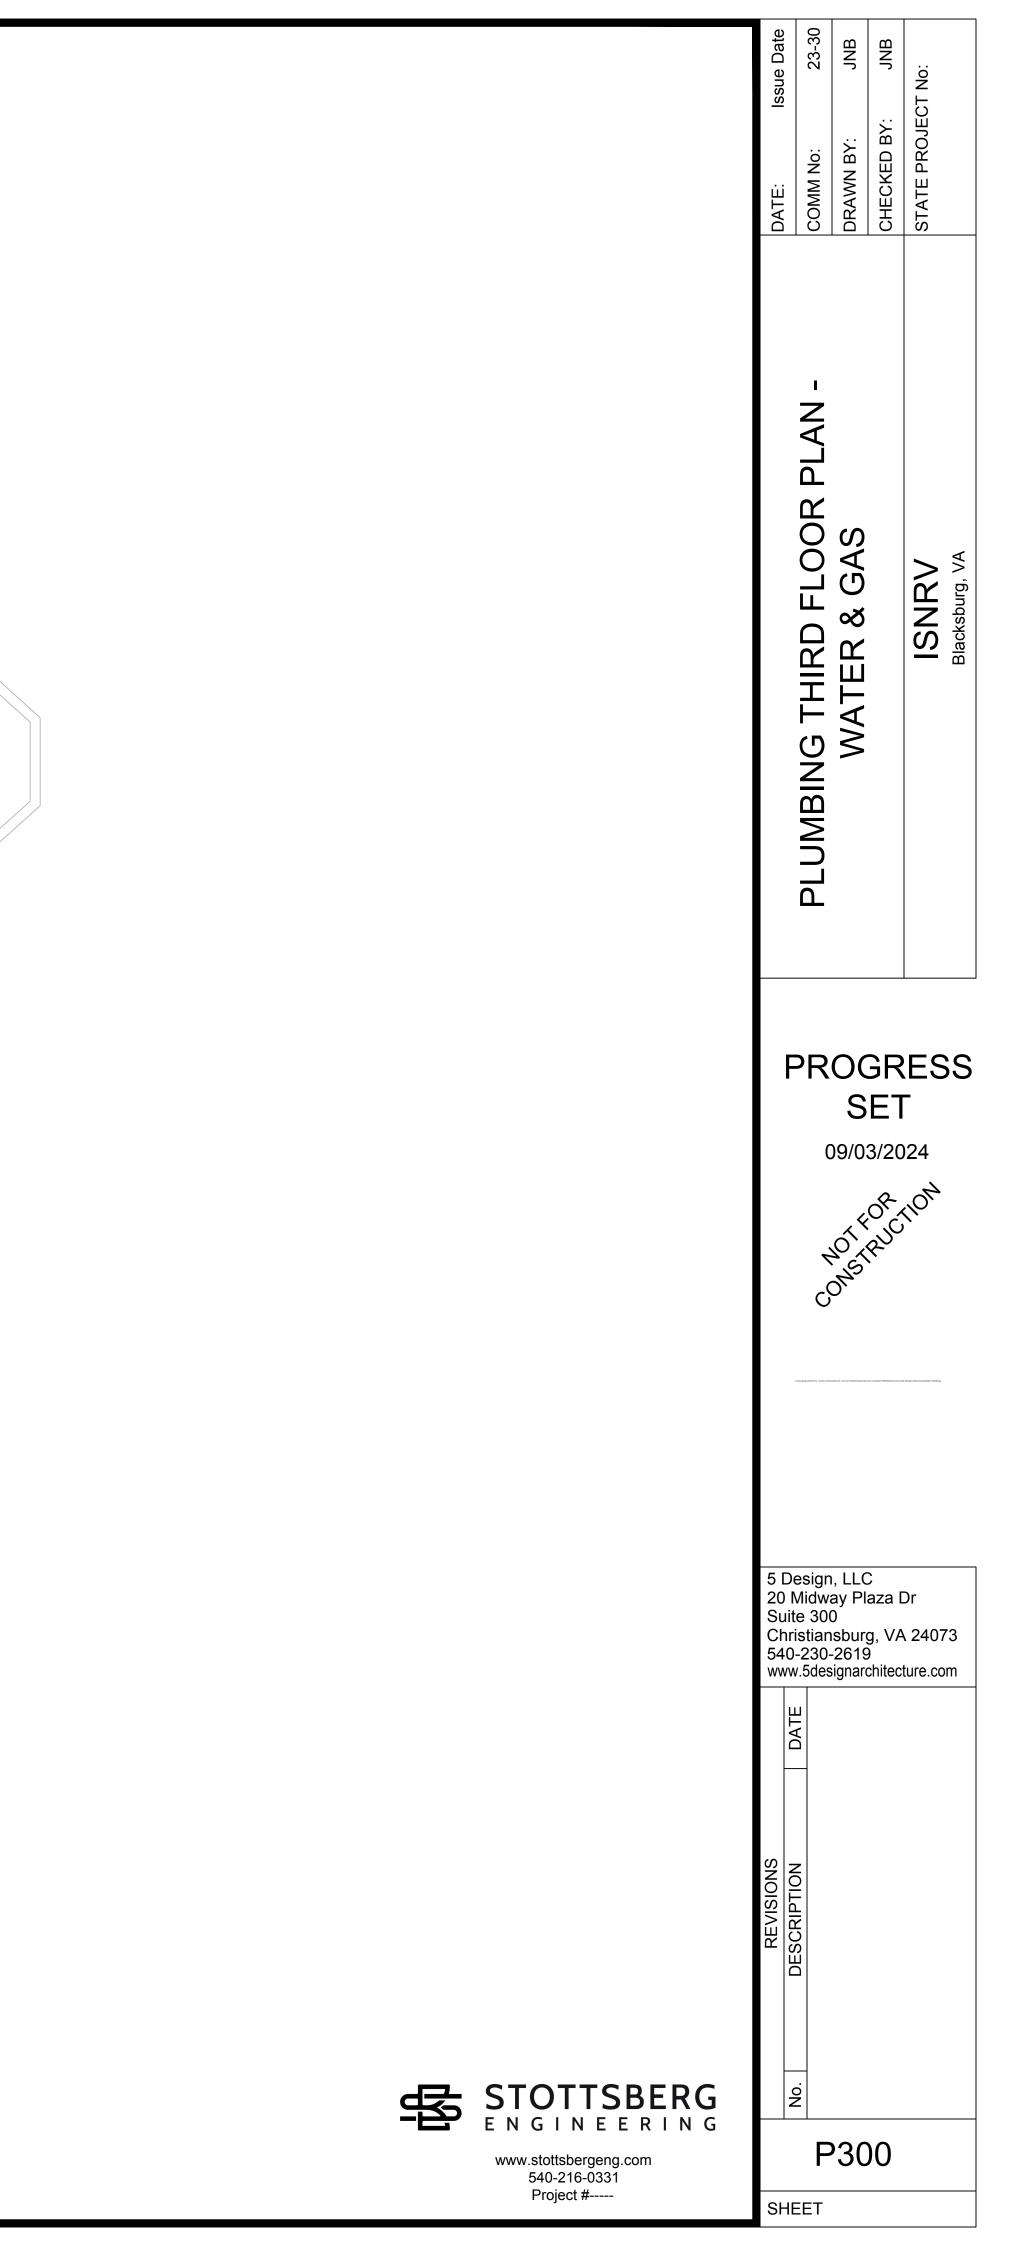

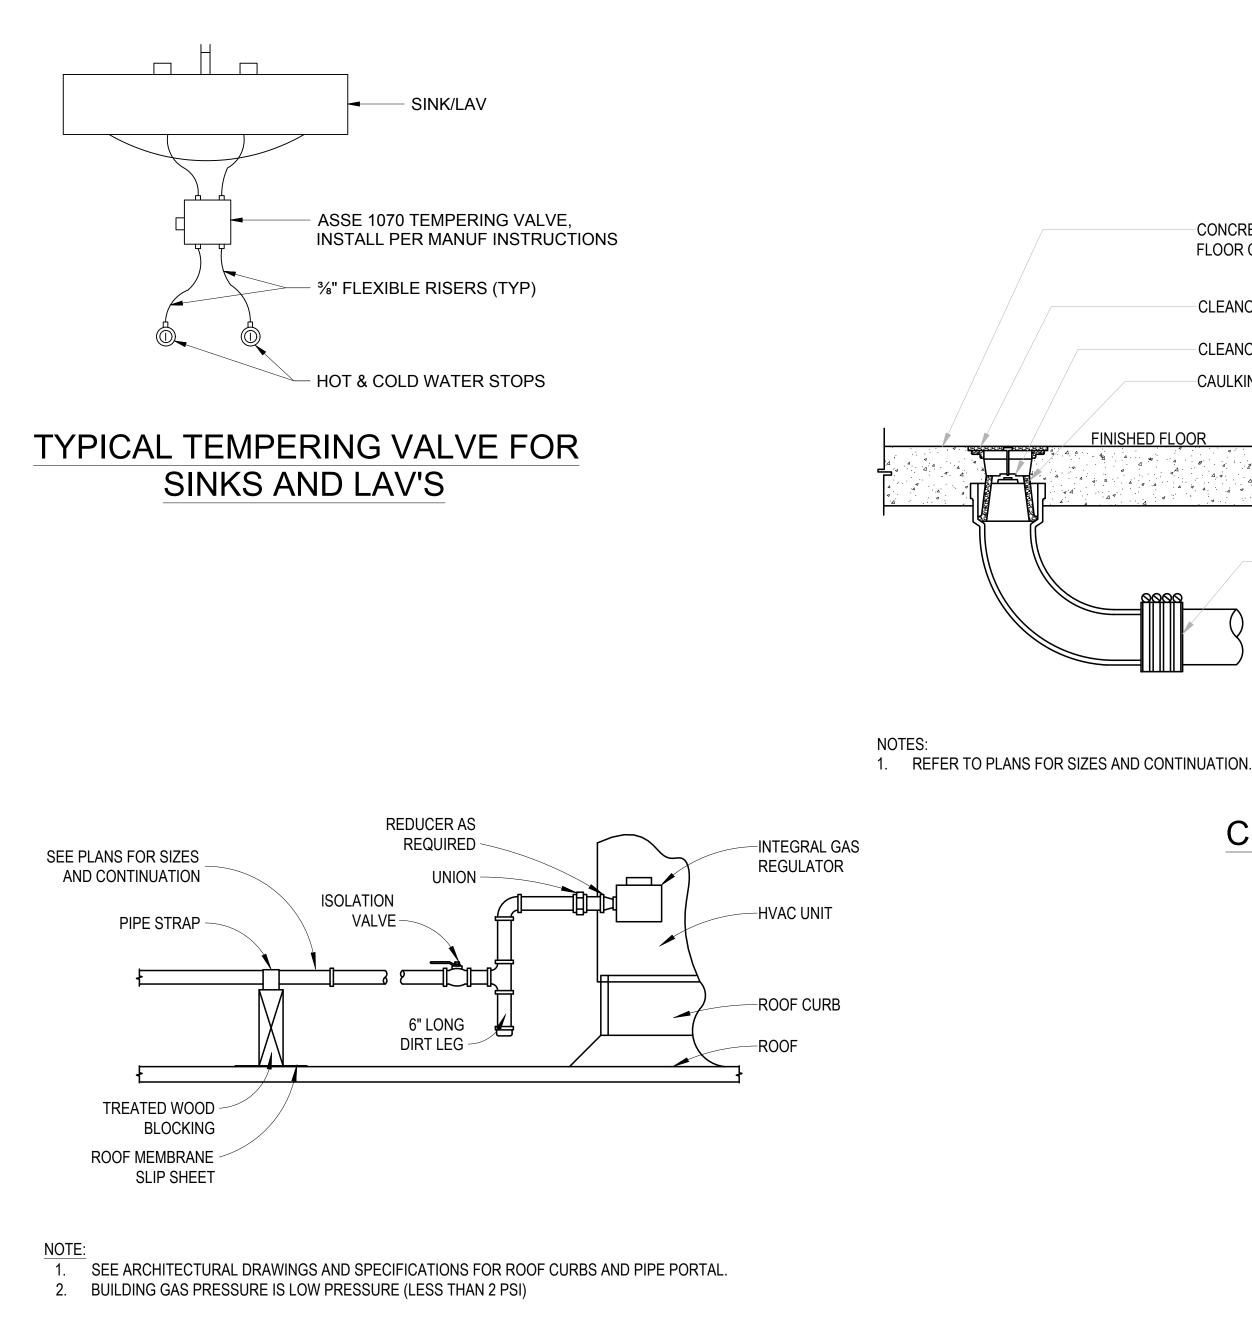CLEANOUT DETAILS




-CONCRETE SURFACE OR

-CLEANOUT COVER

-CLEANOUT PLUG

-CAULKING FERRULE


FLOOR COVERING AS REQUIRED

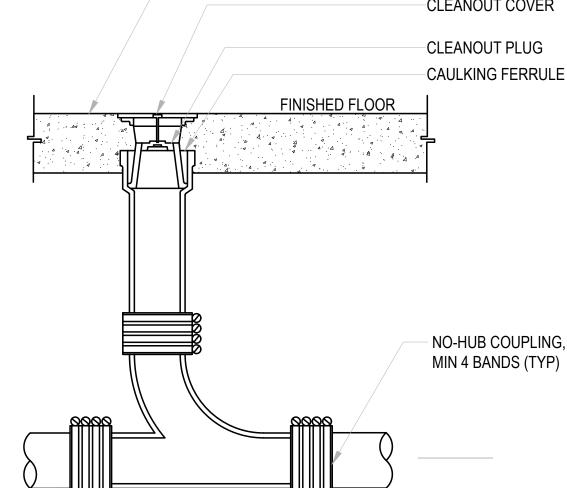

NOTES: 1. REFER TO PLANS FOR SIZES AND CONTINUATION

-CLEANOUT PLUG CAULKING FERRULE

-CONCRETE SURFACE OR FLOOR COVERING AS REQUIRED. CLEANOUT COVER

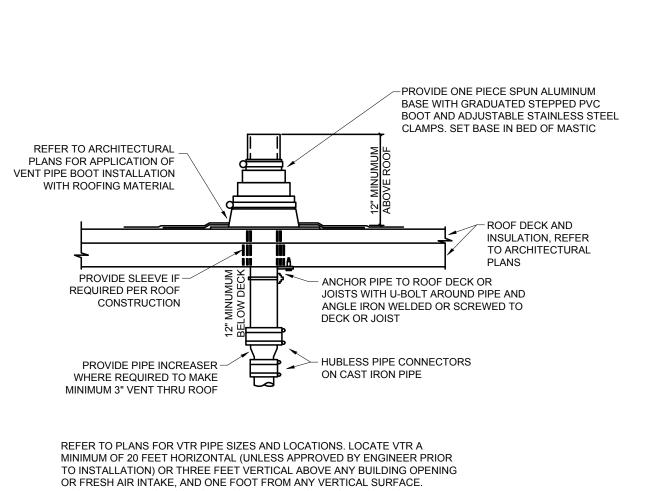

PROVIDE 1" FIBERGLASS INSULATION WITH ALL-SERVICE JACKET ON VENT PIPE INSIDE BUILDING WITHIN SIX FEET OF VENT THRU ROOF LOCATION. VERIFY FLASHING AND COUNTERFLASHING WITH ROOFING CONTRACTOR.

VENT THRU ROOF (VTR) DETAIL

S DETAIL ISNRV PLUMBING

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CHECKED B

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DATE: COMM NG DRAWN E CHECKEI

PROGRESS SET

09/03/2024



5 Design, LLC 20 Midway Plaza Dr Suite 300 Christiansburg, VA 24073 540-230-2619 www.5designarchitecture.com

P400 SHEET



540-216-0331 Project #-----

PLUMBING SPECIFICATIONS:

- 1. GENERAL PROVISIONS:
 - 1.A. ALL WORK SHALL BE IN ACCORDANCE WITH THE 2018 VIRGINIA UNIFORM STATEWIDE BUILDING CODE, ALL FEDERAL, STATE, AND CITY CODES, ORDINANCES, AND STANDARDS.
 - 1.B. THE PLANS ARE DIAGRAMMATIC IN NATURE AND BASED ON ONE MANUFACTURER'S EQUIPMENT. THEY ARE NOT INTENDED TO SHOW EVERY ITEM IN ITS EXACT LOCATION, THE EXACT DIMENSIONS, OR ALL THE DETAILS OF THE EQUIPMENT. VERIFY THE ACTUAL DIMENSIONS OF THE EQUIPMENT PROPOSED TO BE USED. INSTALLATION SHALL BE WITHIN THE LIMITATIONS IMPOSED BY THE ARCHITECTURAL, STRUCTURAL, HVAC, ELECTRICAL, AND PLUMBING REQUIREMENTS WITH ADEQUATE SPACE FOR MAINTENANCE.
 - 1.C. GUARANTEE: ALL MATERIALS AND WORKMANSHIP SHALL BE GUARANTEED TO BE FREE FROM DEFECTS FOR A PERIOD OF ONE (1) YEAR FROM DATE OF ACCEPTANCE AND CONTRACTOR SHALL MAKE GOOD, WITHOUT ADDITIONAL COST TO THE OWNER, ANY DEFECTS WHICH MAY APPEAR WITHIN THAT PERIOD. MANUFACTURER'S WARRANTIES EXTENDING BEYOND ONE YEAR SHALL BE PROCESSED AND TURNED OVER TO THE OWNER.
 - 1.D. MAJOR ITEMS ARE SHOWN ON THE PLANS. THE CONTRACTOR SHALL BE RESPONSIBLE FOR ALL INCIDENTAL ITEMS REQUIRED TO PROVIDE A COMPLETE AND FUNCTIONAL SYSTEM.
 - 1.E. A TRADE NAMES AND CATALOG NUMBERS SHALL BE INTERPRETED AS ESTABLISHING A GENERAL DESIGN AND STANDARD OF QUALITY AND SHALL NOT BE CONSTRUED AS LIMITING COMPETITION. UNLESS STATED OTHERWISE, THE CONTRACTOR MAY USE ANY ARTICLE WHICH, IN HIS JUDGEMENT, AND WITH WRITTEN COMMENT FROM THE ARCHITECT/ENGINEER INDICATING NO OBJECTION, IS EQUAL OR SUPERIOR TO THAT SPECIFIED. DRAWINGS SHOWING CHANGES OR REVISIONS REQUIRED BY THE SUBSTITUTION FOR SPECIFIED ITEMS SHALL BE SUBMITTED WITH THE SHOP DRAWING DATA, AND THE COSTS OF ALL SUCH CHANGES SHALL BE BORNE BY THE CONTRACTOR.
 - 1.F. SIMILAR ITEMS SHALL BE PROVIDED BY A SINGLE MANUFACTURER.
 - 1.G. ALL REQUIRED WALL OR FLOOR OPENINGS SHALL BE COORDINATED WITH THE GENERAL CONTRACTOR AND/OR OTHER RELEVANT TRADES.
 - 1.H. ALL PIPING SHALL BE INSTALLED ABOVE THE CEILING UNLESS INDICATED OTHERWISE. ALL WATER PIPING AND P-TRAPS SHALL BE INSTALLED WITHIN THE BUILDINGS INSULATION ENVELOPE OR BE PROVIDED WITH A FREEZE PROTECTION SYSTEM.
 - 1.I. PROVIDE SUPPORTS TO RIGIDLY ATTACH ALL EQUIPMENT, APPURTENANCES AND PIPE AS REQUIRED FOR SUPPORT. PRIOR TO INSTALLATION OF HANGERS AND INSERTS, THE CONTRACTOR SHALL COORDINATE LOCATIONS AND REQUIREMENTS TO MINIMIZE CONFLICTS WITH OTHER BUILDING SYSTEMS. INSTALLATION OF PIPE HANGERS AND SUPPORTS SHALL BE IN STRICT ACCORDANCE WITH MANUFACTURERS STANDARDIZATION SOCIETY (MSS) STANDARDS SP-58, 69 AND 89.
 - 1.J. THE CONTRACTOR SHALL MAKE FINAL CONNECTIONS TO ALL EQUIPMENT INDICATED TO BE FURNISHED BY OTHERS.
- 2. SUBMITTAL AND SHOP DRAWINGS:
 - 2.A. SUBMIT MANUFACTURER'S CERTIFIED DATA RELATIVE TO ALL EQUIPMENT, PIPING, CONTROLS, ETC. REQUIRED FOR THE INSTALLATION OF THE PLUMBING AND FIRE PROTECTION SYSTEMS. SUBMIT FOR REVIEW ALL NECESSARY ENGINEERING, PRODUCT AND INSTALLATION DATA, SHOP DRAWINGS, SAMPLES ETC. FOR ALL EQUIPMENT, MATERIAL, AND SYSTEMS TO ASCERTAIN COMPLIANCE WITH THE TECHNICAL REQUIREMENTS OF THE CONTRACT DOCUMENTS.
 - 2.B. SUBMIT A DIGITAL PDF OF ALL NECESSARY DATA, CUTS, MANUFACTURER'S SELECTIONS, CATALOGS, BULLETINS, INSTALLATION INSTRUCTIONS, DRAWINGS, DIAGRAMS, CURVES, ETC. CLEARLY INDICATE ON THE SUBMITTED DATA, THE MANUFACTURER'S NAME, PRODUCT NUMBER(S), OPTIONS, EQUIPMENT CAPACITY, DIMENSIONAL DATA, WEIGHTS, AND OTHER APPLICABLE TECHNICAL DATA FOR THE PROJECT.
 - 2.C. TRADE NAMES, MANUFACTURERS, AND CATALOGUE NUMBERS ARE MENTIONED HEREIN AND ON THE DRAWINGS SOLELY IN ORDER TO ESTABLISH A STANDARD FOR THE TYPE, GENERAL DESIGN, AND QUALITY OF PRODUCT REQUIRED. OTHER PRODUCTS SIMILAR IN DESIGN OF EQUIVALENT QUALITY CAPABLE OF FITTING WITHIN THE SPACES ALLOCATED AND COMPLYING WITH THE DRAWINGS AND SPECIFICATIONS WILL BE CONSIDERED AFTER THE CONTRACT IS LET

UNLESS "PRIOR APPROVAL" REQUIREMENTS A FORTH IN THESE DOCUMENTS.

- 2.D. REVIEW OF SUBMITTALS AND SHOP DRAWING NOT RELIEVE THE CONTRACTOR OF THE RESPONSIBILITY FOR FITTING THE EQUIPMENT SPACE ALLOTTED WITH SPACE FOR ALL CONN AND SERVICING AND FOR THE COORDINATION WORK WITH WORK OF OTHER TRADES.
- 2.E. THE CONTRACTOR SHALL REVIEW ALL SUBMIT SHOP DRAWINGS AND INDICATE BY STAMP OR THAT HE HAS REVIEWED THEM, BEFORE FORW THEM TO THE ARCHITECT AND/OR ENGINEER. SUBMITTALS AND DRAWINGS WILL BE RETURN REVIEW INDICATING WHETHER EXCEPTIONS A THE SUBMITTAL RETURNED WITH CORRECTION COMPLETELY REJECTED. RESUBMISSION OF F SUBMITTALS AND SHOP DRAWINGS, IF REQUIN BE DONE BEFORE INSTALLATION AND CONSTR BEGUN.
- 2.F. CORRECTIONS OR COMMENTS MADE ON TH SUBMITTALS AND DRAWINGS DURING THIS DOES NOT RELIEVE THE CONTRACTOR FRO COMPLIANCE WITH THE REQUIREMENTS OF CONTRACT DOCUMENTS. THIS REVIEW IS F CONFORMANCE WITH THE DESIGN CONCEP PROJECT AND GENERAL COMPLIANCE WITH INFORMATION GIVEN IN THE CONTRACT DO THE CONTRACTOR IS RESPONSIBLE FOR CO AND CORRELATING ALL QUANTITIES AND D FABRICATION PROCESSES, TECHNIQUES O CONSTRUCTION, COORDINATING THE WOR OF ALL OTHER TRADES. AND PERFORMING SAFE AND SATISFACTORY MANNER. REVIEW SUBMITTALS SHALL NOT PERMIT ANY DEVIA PLANS AND SPECIFICATIONS.
- 3. AS-BUILT DRAWINGS:
 - 3.A. MAINTAIN DAILY UPDATED DRAWINGS SHOWIN DEVIATIONS FROM CONSTRUCTION DOCUMEN THE END OF THE PROJECT, PROFESSIONALLY AS-BUILT DRAWINGS AND SUBMIT DRAWINGS ARCHITECT/ENGINEER.
- 4. OPERATION AND MAINTENANCE MANUALS:
- 4.A. UPON COMPLETION OF THE PROJECT, SUBMIT OPERATION AND MAINTENANCE MANUALS, WARRANTIES, SPARE PARTS LIST, AS-BUILT DI TEST AND BALANCE REPORTS, AND LETTER O GUARANTEE ALL BOUND IN THREE RING BINDE CLEARLY SHOWING WHICH EQUIPMENT WAS S TO THE JOB.
- 5. PIPING SPECIALTIES:
- 5.A. ACCESS DOORS: ACCESS DOORS SHALL BE PI FOR ALL CONCEALED VALVES, CONTROLS, AN OTHER EQUIPMENT OR MATERIALS REQUIRING INSPECTION OR MAINTENANCE. ACCESS DOOF BE FURNISHED FOR FLOORS, WALLS AND CEIL ADEQUATE SIZE SO THAT CONCEALED ITEMS READILY ACCESSIBLE FOR SERVICING OR FOF AND REPLACEMENT IF NECESSARY.
- 5.B. PIPE ESCUTCHEONS: INSTALL PIPE ESCUTCHE EACH PIPE PENETRATION THRU FLOORS, WAL PARTITIONS, AND CEILINGS WHERE PENETRAT EXPOSED TO VIEW AND ON EXTERIOR OF BUIL SECURE ESCUTCHEON TO PIPE OR INSULATIO ESCUTCHEON COVERS PENETRATION HOLE, A FLUSH WITH ADJOINING SURFACE. PROVIDE S STEEL ESCUTCHEONS, SOLID OR SPLIT HINGE AREAS WHERE WATER AND CONDENSATION O EXPECTED TO ACCUMULATE, PROVIDE CAST E SHEET BRASS ESCUTCHEONS, SOLID OR SPLIT
- 5.C. PIPE SLEEVES: INSTALL PIPE SLEEVES WHE PASSES THROUGH WALLS, FLOORS, CEILING ROOFS. DO NOT INSTALL SLEEVES THROUG STRUCTURAL MEMBERS OF WORK, EXCEPT ON DRAWINGS, OR AS REVIEWED BY ARCHITECT/ENGINEER. SIZE SLEEVES SO T AND INSULATION (IF ANY) WILL HAVE FREE SLEEVE, INCLUDING ALLOWANCE FOR THEF EXPANSION; BUT NOT LESS THAN 2 PIPE SIZ THAN PIPING RUN. INSTALL LENGTH OF SLE TO THICKNESS OF CONSTRUCTION PENETR FINISH FLUSH TO SURFACE; EXCEPT FLOOF EXTEND FLOOR SLEEVES 1/4 INCH ABOVE L FINISH, AND 3/4 INCH ABOVE FLOOR FINISH DRAIN. PROVIDE TEMPORARY SUPPORT OF DURING PLACEMENT OF CONCRETE AND O AROUND SLEEVES. AND PROVIDE TEMPORA TO PREVENT CONCRETE AND OTHER MATER ENTERING SLEEVES.
- 5.D. WATER HAMMER ARRESTORS (WHA): PROVID FAST OPENING WATER VALVES INCLUDING WA CLOSETS, URNIALS, AND CLOTHES WASHERS. ZURN MODEL 1260XL OR EQUIVALENT AND SH SIZED AND PLACED WITHIN THE SYSTEM AS RECOMMENDED BY THE MANUFACTURER.

TS ARE SET		FLAME/SMOKE RATINGS: PROVIDE COMPOSITE	
INGS DOES		PLUMBING INSULATION (INSULATION, JACKETS, COVERINGS, SEALERS, MASTICS AND ADHESIVES) WITH FLAME-SPREAD RATING OF 25 OR LESS, AND	
IENT IN THE	:	SMOKE-DEVELOPED RATING OF 50 OR LESS, AS TESTED	
ONNECTIONS		BY ASTM E84 METHOD. INSULATION SHALL BE LABELED BY THE MANUFACTURER. THE LABEL SHALL INDICATE	
		THE INSULATING VALUE, FLAME SPREAD AND SMOKE-DEVELOPED RATING.	
BMITTALS AND			
OR LETTER	-	INSTALLATION: INSULATION SHALL BE APPLIED IN ACCORDANCE WITH MANUFACTURER'S	
ER. URNED AFTER		RECOMMENDATIONS USING ONLY ADHESIVES, MASTICS AND PLUMBING FASTENERS APPROVED BY THE	
IS ARE TAKEN,		INSULATION MANUFACTURER. INSULATION SHALL NOT	
TIONS, OR IS OF REVISED		BE APPLIED UNTIL AFTER THE EQUIPMENT HAS BEEN TESTED WITH RESULTS ACCEPTABLE TO THE	
QUIRED, SHALL		ARCHITECT/ENGINEER. INSULATION WITH A VAPOR BARRIER JACKET SHALL BE APPLIED WITH A	
		CONTINUOUS, UNBROKEN VAPOR SEAL AND ALL JOINTS	
ΉE		SHALL BE SEALED WITH A VAPOR BARRIER ADHESIVE UNLESS OTHERWISE INDICATED. STAPLES, STICK CLIPS	
S REVIEW		AND HANGERS SHALL BE VAPOR SEALED WHERE THEY PUNCTURE VAPOR BARRIER JACKETS.	
OM F THE			
FOR GENERAL PT OF THE	6.C.	MATERIALS:	
H THE DCUMENTS.	6.C.A		
CONFIRMING		PREFORMED PIPE INSULATION WITH OPERATING TEMPERATURE RANGE OF -60 DEGREES F TO 350	
DIMENSIONS, DF		DEGREES F, THERMAL CONDUCTIVITY "K"=0.24 BTU-IN/HOUR-SF-DEG F AT 100 DEGREES F.	
RK WITH THAT G WORK IN A		FACTORY APPLIED JACKET (ASJ) SHALL CONSIST OF	
EW OF THE		WHITE KRAFT PAPER BONDED TO ALUMINUM FOIL AND REINFORCED WITH GLASS FIBER YARN. EQUAL	
ATION FROM		TO OWENS-CORNING ASJ.	
	6.C.E	 CELLULAR FOAM PIPE INSULATION: TUBULAR, FLEXIBLE, FIRE RESISTANT INSULATION WITH 	
WING MENTS. AT		OPERATING TEMPERATURE RANGE OF -40 DEGREES	
LLY PREPARE		F TO 220 DEGREES F, THERMAL CONDUCTIVITY "K"=0.27 BTU-IN/HOUR-SF-DEG F AT 75 DEGREES F.	
GS TO THE		NO JACKET REQUIRED. EQUAL TO ARMSTRONG ARMAFLEX AP.	8
BMIT ALL	6.C.C	C. A POLYETHYLENE PIPE INSULATION: INSULATION MATERIALS CORPORATION OF AMERICA (IMCOA),	
, T DRAWINGS,		FLEXIBLE CLOSED CELL POLYETHYLENE TUBING, ASTM C534, "K"=0.24 AT 75 DEGREES F, SERVICE	ç
R OF NDERS,		TEMPERATURE -110F TO 210F. NO JACKET	
AS SUPPLIED		REQUIRED.	
		OMIT INSULATION ON EXPOSED PLUMBING FIXTURE RUNOUTS FROM FACES OF WALL OR FLOOR TO FIXTURE;	
E PROVIDED		ON UNIONS, FLANGES, STRAINERS, FLEXIBLE CONNECTIONS, AND EXPANSION JOINTS.	
, AND ANY		CONNECTIONS, AND EXTANSION JOINTS.	1
RING OORS SHALL		COVER VALVES, FITTINGS AND SIMILAR ITEMS IN EACH PIPING SYSTEM WITH EQUIVALENT THICKNESS AND	
CEILINGS, OF MS WILL BE		COMPOSITION OF INSULATION AS APPLIED TO ADJOINING PIPE RUN.	
FOR REMOVAL			
		ALL DOMESTIC WATER PIPING ABOVE GROUND INCLUDING COLD, HOT, AND HOT WATER	
CHEONS ON VALLS		RE-CIRCULATING PIPING SHALL BE INSULATED WITH A MINIMUM 1/2" THICK INSULATION.	
RATION IS BUILDING.			
ATION SO .E, AND IS	7. PLUMBI 7.A.	NG PIPING: DOMESTIC WATER PIPING SHALL BE COPPER TUBE AND	
E SHEET		FITTINGS IN ACCORDANCE WITH ASTM B88, TYPE L HARD DRAWN COPPER. JOINTS SHALL BE MADE WITH LEAD	
NGED. FOR DN CAN BE		FREE SOLDER.	
ST BRASS OR SPLIT HINGED.		STORM, SOIL, WASTE, AND VENT PIPING BELOW GRADE	
-		SHALL BE SCHEDULE 40 PVC PIPE AND FITTINGS. PVC SCHEDULE 40 PIPE SHALL BE IRON PIPE SIZE (IPS)	
ERE PIPING NGS, AND		CONFORMING TO ASTM D 1785. INJECTION MOLDED PVC	
GH T AS DETAILED		SCHEDULE 40 FITTINGS SHALL CONFORM TO ASTM D 2466. PIPE AND FITTINGS SHALL BE MANUFACTURED AS	
THAT PIPING		A SYSTEM AND BE THE PRODUCT OF ONE MANUFACTURER. PIPE AND FITTINGS SHALL CONFORM	
MOVEMENT IN		TO NSF INTERNATIONAL STANDARD 61 AND THE HEALTH-EFFECTS PORTION OF NSF STANDARD 14.	
RMAL IZES LARGER			
EEVE EQUAL RATED, AND		STORM, SOIL, WASTE, AND VENT PIPING ABOVE GRADE SHALL BE HUBLESS CAST IRON TYPE DESIGNED FOR	
R SLEEVES.	:	SAID APPLICATION. HUBLESS CAST IRON PIPE AND	1
LEVEL FLOOR I SLOPED TO	l	FITTINGS SHALL BE MANUFACTURED FROM GRAY CAST IRON AND SHALL CONFORM TO ASTM A 888 AND CISPI	
F SLEEVES DTHER WORK		STANDARD 301. ALL PIPE AND FITTINGS SHALL BE MARKED WITH THE COLLECTIVE TRADEMARK OF THE	
ARY CLOSURE		CAST IRON SOIL PIPE INSTITUTE® AND LISTED BY NSF®	
ERIALS FROM		TO CISPI STANDARD 310, SHALL BE MANUFACTURED IN	
VIDE AT ALL		THE UNITED STATES, AND BE CERTIFIED BY NSF® INTERNATIONAL.	
WATER RS. SHALL BE	ח 7	CONDENSATE DRAINS SHALL BE TYPE L HARD DRAWN	
SHALL BE		COPPER. JOINTS SHALL BE MADE WITH LEAD FREE	
S		SOLDER.	E

7.E. SLOPE ALL DRAIN LINES AT 1/4 INCH PER FOOT FOR

SIZES LESS THAN 4 INCHES. SLOPE AT FOOT FOR SIZES 4 INCH AND LARGER.

- 7.F. SOIL, WASTE, AND VENT PIPING BELOW O A MINIMUM OF 2 INCH AND SHALL BE PRO METALLIC TRACING/DETECTION WIRE.
- 7.G. VENTS SHALL EXTEND A MINIMUM OF 12 THE ROOF. ROOF FLASHING SHALL BE I COORDINATED WITH THE GENERAL AND CONTRACTORS.
- 7.H. TRENCHING AS REQUIRED FOR UNDERG SHALL BE GRADED TO UNIFORM PITCH A WIDER THAN NECESSARY FOR PIPING IN CLEAN BACKFILL SHALL BE USED AND TH TAMPED IN LAYERS NOT EXCEEDING 6 IN MINIMUM DEPTH OF 1 FOOT ABOVE PIPE BACKFILL SHALL BE USED FOR THE ENTI EXCAVATION UNDER SLAB ON GRADE CO
- 7.I. NATURAL GAS SYSTEMS: PIPING SHALL 40 BLACK STEEL PIPE, ASTM A120/A53-C GRADE B (WELDED OR SEAMLESS); WRC BUTTWELDING FITTINGS. GAS COCKS 2 SMALLER SHALL BE RATED FOR 150 PSI, WOG, BRONZE STRAIGHTWAY COCK, FL HEAD, WITH THREADED ENDS. ALL GAS CONNECTIONS SHALL BE PROVIDED WIT TRAP, UNION, AND GAS COCK SHUT OFF JOINTS SHALL BE SEALED WITH CHEMIC SEALER APPLIED TO MALE THREADS OF CONNECTION. GAS PIPING SHALL BE IN 1/64 INCH PER FOOT DOWNWARD SLOPE DIRECTION OF FLOW. A ROLLER BEARIN SUPPORT SHALL BE USED TO SUPPORT LOCATED ON THE ROOF. SUPPORTS SH POLYCARBONATE BASE. WITH PIPE RES LUBRICATING POLYCARBONATE RESIN A ROLLER AND BE SIZED FOR THE PIPE BE SUPPORTED. MAXIMUM SPACING SHALL 10FT.
- 8. PLUMBING FIXTURES, PUMPS, AND WATER HEAT PROVIDED AND INSTALLED AS PER THE PLUMBIN SCHEDULE. ALL EXPOSED FIXTURE SUPPLIES A LINES SHALL BE CHROME PLATED. NO EXPOSED AND/OR CAST IRON IS ALLOWED.
- 9. CLEANOUTS SHALL BE THE SAME SIZE AS LINE S NOT LARGER THAN 4 INCHES, AND SHALL BE PR BASE OF EACH SOIL AND WASTE STACK, AT ALL DIRECTION CHANGE IS MORE THAN 45 DEGREES INTERVALS OF 50 FEET FOR 4 INCH AND SMALLE MINIMUM INTERVALS OF 100 FEET FOR PIPING LA INCHES, AS REQUIRED BY CODE AND AS INDICAT DRAWINGS. COVERS SHALL BE SET FLUSH WITH WALL.
- 10. PLUMBING VALVES
 - 10.A. PROVIDE SHUT-OFF VALVE AND UNION O AT EACH HOT AND COLD WATER EQUIPM CONNECTION. PROVIDE SHUTOFF VALVE BRANCH OR RISER THAT SERVES TWO O PLUMBING FIXTURES.
 - 10.B. GATE VALVES 2-1/2 INCHES AND SMALLE RISING STEM, SOLID WEDGE DISC. STOC B-108.
 - 10.C. GLOBE VALVES: ALL BRONZE, RENEWABI COMPOSITION DISC. STOCKHAM B-16 OR
 - 10.D. CHECK VALVES IN HORIZONTAL PIPES: 2 SMALLER: ALL BRONZE, REGRINDING BR HORIZONTAL SWING, Y-PATTERN. STOCK B-309.
 - 10.E. CHECK VALVES IN VERTICAL PIPES AND I DISCHARGE: SILENT CHECK VALVE WITH BODY, BRONZE TRIM AND STAINLESS STE METRAFLEX 700 SERIES.
 - 10.F. BALL VALVES MAY BE USED IN LIEU OF G INCHES AND SMALLER. BALL VALVES SHA BRONZE BODY, BRONZE BALL AND TFE S SEALS. STOCKHAM S-216BRRT OR S-216E
- 11. CLEANING AND TESTING
 - 11.A. ALL WATER PIPING, VALVES, ETC. SHALL THOROUGHLY FLUSHED OF FOREIGN MA TESTED FOR LEAKS IN ACCORDANCE WI PLUMBING AND BUILDING CODE, LATEST LEAKAGE SHALL BE REPAIRED. DISINFEC WATER PIPING INCLUDING WATER SERVI ACCORDANCE WITH AWWA C601.
 - 11.B. ALL DRAIN, WASTE AND VENT PIPING SH FOR LEAKS IN ACCORDANCE WITH THE I BUILDING CODE CODE, LATEST EDITION DROP IN WATER LEVEL WILL BE ACCEPT

END OF SPECIFICATIONS.

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1/8 INCH PER		Issue Date	23-30	JNB	JNB	:. N
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