
#### PLUMBING ABBREVIATIONS

۸ ۸ ۸ /	AID ADMITTANCE VALVE	1 IVA/T	LIOT MATER TANK
AAV	AIR ADMITTANCE VALVE	HWT	HOT WATER TANK
AC	AIR COMPRESSOR		
AD	AREA DRAIN	INV. EL.	INVERT ELEVATION
AFF		1144	IIIV EICH ELEVICION
	ABOVE FINISHED FLOOR		
AFG	ABOVE FINISHED GRADE	KS	KITCHEN SINK
ASC	ABOVE SUSPENDED CEILING		
AV	ACID VENT	LAV	LAVATORY
AW	ACID WASTE	LPD	LOW POINT DRAIN
AWC	AUTOMATIC WASHER CONNECTION	LT	LAUNDRY TUB
BAV	BALANCING VALVE	M	METER
BC	BALANCING COCK	MC	MECHANICAL CONTRACTOR
BFP	BACKFLOW PREVENTER	MH	MANHOLE
BT	BATHTUB	MSB	MOP SERVICE BASIN
BTU	BRITISH THERMAL UNIT	MV	MIXING VALVE
		IVIV	WINING VALVE
BV	BALL VALVE		
		NIC	NOT IN CONTRACT
CA	COMPRESSED AIR	NPW	NON-POTABLE WATER
СВ	CATCH BASIN	NTS	NOT TO SCALE
CFH	CUBIC FEET PER HOUR		
CHKV	CHECK VALVE	Ol	OIL INTERCEPTOR
CI	CAST IRON	OS&Y	OUTSIDE SCREW & YOKE
CO	CLEANOUT	OSI	OIL SEDIMENT INTERCEPTOR
CS	CLINICAL SINK	OSW	OPEN SITE WASTE
CSS	CLINICAL SERVICE SINK		
CW	COLD WATER	Р	PUMP
CWP	CIRCULATING WATER PUMP	PC	PLUMBING CONTRACTOR
		PD	PUMP DISCHARGE
D	DRAIN LINE	PRV	PRESSURE REDUCING VALVE
		PT	PLASTER TRAP
DF	DRINKING FOUNTAIN		
DI	DISTILLED WATER	PVC	POLYVINYL CHLORIDE
DIW	DEIONIZED WATER		
DN	DOWN	RD	ROOF DRAIN
DS	DOWNSPOUT	RH	ROOF HYDRANT
DSN	DOWN SPOUT NOZZLE	RV	RELIEF VENT
DWH	DOMESTIC WATER HEATER	RWL	RAIN WATER LEADER
DWV	DROP TO WASTE/RISE TO VENT		
DVVV	BROF TO WASTERNISE TO VENT	0.4.1	CANITARY OF MED
		SAN	SANITARY SEWER
EC	ELECTRICAL CONTRACTOR	SCW	SOFTENED COLD WATER
EST	EMERGENCY STORM SEWER	SD	SCRUBBER DRAIN
ET		SE	SEWAGE EJECTOR
	EXPANSION TANK		
EWC	ELECTRIC WATER COOLER	SF	SQUARE FOOT
EWH	ELECTRIC WATER HEATER	SHR	SHOWER
EXST	EXISTING	SK	SINK
LASI	LAIGHING		
		SMP	SUMP PUMP
F	FAHRENHEIT DEGREES	SS	SERVICE SINK
FACP	FIRE ALARM CONTROL PANEL	SSS	SURGICAL SERVICE SINK
FBO	FURNISHED BY OTHERS	ST	STORM SEWER
FCO	FLOOR CLEANOUT	STN	STRAINER
FD	FLOOR DRAIN	SWE	STORM WATER EJECTOR
FDC	FIRE DEPARTMENT CONNECTION		
FE	FIRE EXTINGUISHER	TFA	TO FLOOR ABOVE
FEC	FIRE EXTINGUISHER CABINET	TFB	TO FLOOR BELOW
FFA	FROM FLOOR ABOVE	TP	TRAP PRIMER
FFB	FROM FLOOR BELOW	TW	TEMPERED WATER
FH	FIRE HYDRANT	LID	LIDINIAL
FHC	FIRE HOSE CABINET	UR	URINAL
FP	FIRE PROTECTION PIPING		
FS	FLOOR SINK	V	VENT
		VAC	VACUUM
FT	FOOTING TILE		
		VB	VACUUM BREAKER
G	GAS	VC	VALVE CABINET
GC	GENERAL CONTRACTOR	VR	VENT RISE
		VTR	VENT THROUGH ROOF
GI	GREASE INTERCEPTOR	VIT	VENT THROUGH ROUF
GLV	GLOBE VALVE		
GM	GAS METER	WC	WATER CLOSET
GPH	GALLONS PER HOUR	WCO	WALL CLEANOUT
		WF	WASH FOUNTAIN
GPM	GALLONS PER MINUTE		
GT	GREASE TRAP	WG	WATER GAUGE
GTV	GATE VALVE	WH	WALL HYDRANT
GWH	GAS WATER HEATER	WHA	WATER HAMMER ARRESTOR
GVVH	UNU WATER FEATER		
		WIG	WIRE GUARD
HB	HOSE BIBB	WM	WATER METER
HP	HORSEPOWER	WTCS	WATER TEMPERATURE CONTROL STATION
		WV	WET VENT
HW	HOT WATER	v v V	VVCI VCINI
HWCP	HOT WATER CIRCULATING PUMP		
HWR	HOT WATER RECIRCULATION	YCO	YARD CLEANOUT
114417	HOT WATER INCOME. THOR	YH	YARD HYDRANT
		111	IVINDITION
		<u> </u>	
		ZVB	ZONE VALVE BOX (MEDICAL GAS)

## PLUMBING SYMBOLS - VALVES AND SPECIALTIES

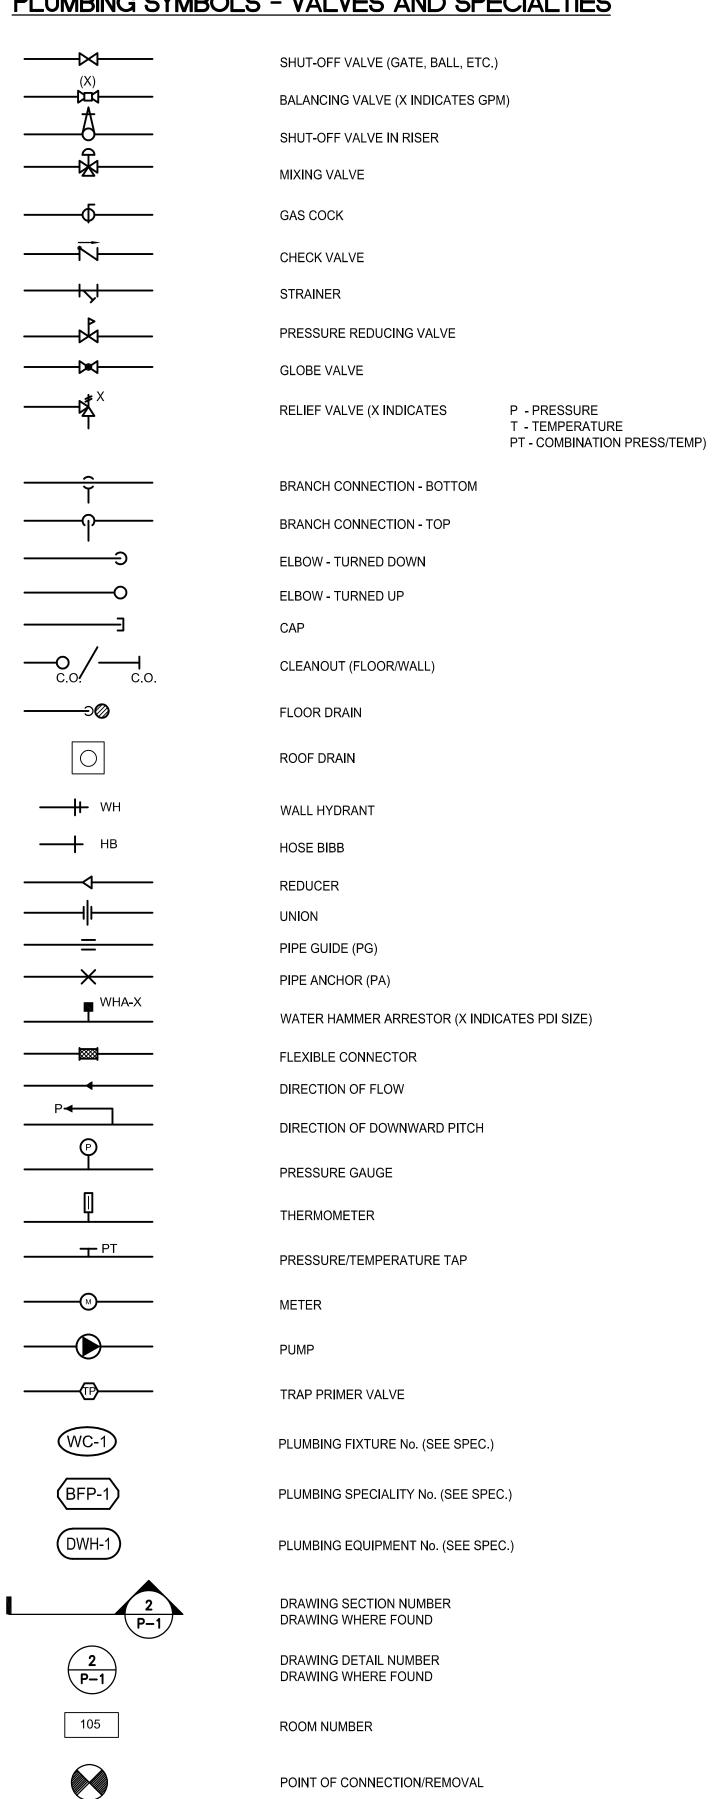

### PLUMBING SYMBOLS - PIPING DESIGNATIONS

CW	COLD WATER
——————————————————————————————————————	HOT WATER
—— HWR ——	HOT WATER CIRCULATING
SAN	SANITARY SEWER
— — V — —	VENT
—— ST ——	STORM SEWER
——— EST ———	EMERGENCY STORM SEWER
——— D ———	DRAIN
——— W ———	WATER MAIN (EXTERIOR)
——— PD ———	PUMP DISCHARGE
——— GAS ———	NATURAL GAS
——— CA ———	COMPRESSED AIR

## GENERAL NOTES

- 1. THIS LEGEND SHEET IS FOR CONTRACTOR REFERENCE ONLY. NOT ALL SYMBOLS AND/OR ABBREVIATIONS MAY APPLY TO THIS PARTICULAR PROJECT. ANY ADDITIONS OR OMISSIONS FROM THIS LEGEND SHEET DOES NOT IMPLY INCLUSION AND/OR EXCLUSION OF ANY PARTICULAR ITEM FROM THE PROJECT.
- 2. THE PLANS ARE DIAGRAMMATIC AND INDICATE ONLY THE SIZE AND GENERAL ARRANGEMENT OF PIPING AND EQUIPMENT. EXACT LOCATION OF ALL ELEMENTS SHALL BE DETERMINED AS WORK PROGRESSES, IN COOPERATION AND COORDINATION WITH THE WORK OF ALL OTHER TRADES. IT IS NOT INTENDED TO SHOW EVERY ITEM OF WORK OR MINOR PIECE OF EQUIPMENT, BUT THE CONTRACTOR SHALL FURNISH AND INSTALL WITHOUT ADDITIONAL REMUNERATION ANY COMPONENT NECESSARY TO COMPLETE THE SYSTEM IN ACCORDANCE WITH THE BEST PRACTICE OF THE TRADE.
- 3. ITEMS OF WORK OR EQUIPMENT SHOWN ON THE DRAWINGS ONLY, OR CALLED FOR IN THE SPECIFICATIONS ONLY, SHALL BE FURNISHED AND INSTALLED IN THE SAME MANNER AS IF THEY APPEARED ON BOTH THE DRAWINGS AND SPECIFICATIONS.
- 4. DRAWINGS DO NOT INDICATE ALL OFFSETS, CHANGES IN ELEVATIONS, ETC. WHICH MAY BE REQUIRED. THE CONTRACTOR SHALL MAKE SUCH CHANGES IN PIPING AND LOCATION OF EQUIPMENT, ETC. TO ACCOMMODATE WORK WITH THAT OF OTHER CONTRACTORS.
- 5. INSTALL EQUIPMENT AND PIPING TO AVOID INTERFERENCE WITH THE OPERATION OR SERVICING AND MAINTENANCE OF EQUIPMENT.
- 6. ALL COSTS FOR CUTTING, PATCHING AND PAINTING OF EXISTING WALLS, CEILINGS AND FLOORS TO ACCOMMODATE THE INSTALLATION OF PLUMBING WORK SHALL BE THE RESPONSIBILITY OF THE PLUMBING CONTRACTOR UNLESS INDICATED OTHERWISE. MATERIALS FOR RESTORATION OF EXISTING SURFACES SHALL MATCH THE EXISTING MATERIALS.
- 7. PIPES PENETRATING FIRE WALLS AND FLOORS SHALL BE FIRESTOPPED AS SPECIFIED. REFER TO THE ARCHITECTURAL DRAWINGS FOR FIRE WALL AND FLOOR LOCATIONS.
- 8. ALL PHYSICAL ATTRIBUTES OF EQUIPMENT AND DEVICES ARE BASED ON THOSE MANUFACTURERS LISTED IN THE SPECIFICATIONS AND/OR THE EQUIPMENT SCHEDULES. THE RESPECTIVE CONTRACTORS ARE RESPONSIBLE FOR ALL CHANGES BROUGHT ABOUT BY USE OF ITEMS BY OTHER MANUFACTURERS. THE ARCHITECT/ENGINEER HAS RESERVED THE RIGHT TO REJECT ITEMS BY OTHER MANUFACTURERS IF THOSE ITEMS DO NOT MATCH THE PHYSICAL ATTRIBUTES OF THE MANUFACTURERS LISTED.
- 9. COMPLY WITH THE VIRGINIA STATE 2015 PLUMBING CODE, ASHRAE 90.1-2007, AND OTHER APPLICABLE CODES.


#### **BLACKSBURG TRANSIT**

**BUILDING ADDRESS** 1324 PERRY STREET, BLACKSBURG, VA 24060

#### **MULTI-MODAL TRANSIT FACILITY**

**BID SET** 



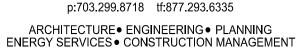



www.wendelcompanies.com




DAA Project No. B10172B-05

NOTE:
THIS DOCUMENT, AND THE IDEAS AND DESIGNS INCORPORATED HEREIN, AS AN INSTRUMENT OF PROFESSIONAL SERVICE, IS THE PROPERTY OF THE ARCHITECT AND ENGINEER AND IS NOT TO BE USED IN WHOLE OR IN PART, FOR ANY OTHER PROJECT WITHOUT THE WRITTEN AUTHORIZATION OF THE ARCHITECT AND ENGINEER. UNAUTHORIZED ALTERATION OR ADDITION TO ANY SURVEY DRAWING, DESIGN, SPECIFICATION, PLAN OR REPORT IS PROHIBITED IN

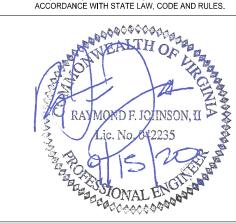

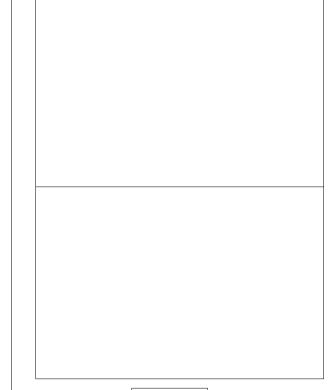

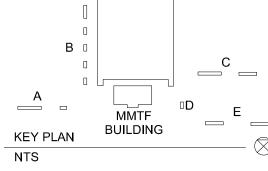


REVISIONS

DWG. TITLE

**PLUMBING** SYMBOLS, NOTES, & **ABBREVIATIONS** 

DATE SEPTEMBER 15, 2020 SCALE AS NOTED DWN. TIP снк. CRL PROJ. No. 449803 DWG. No.

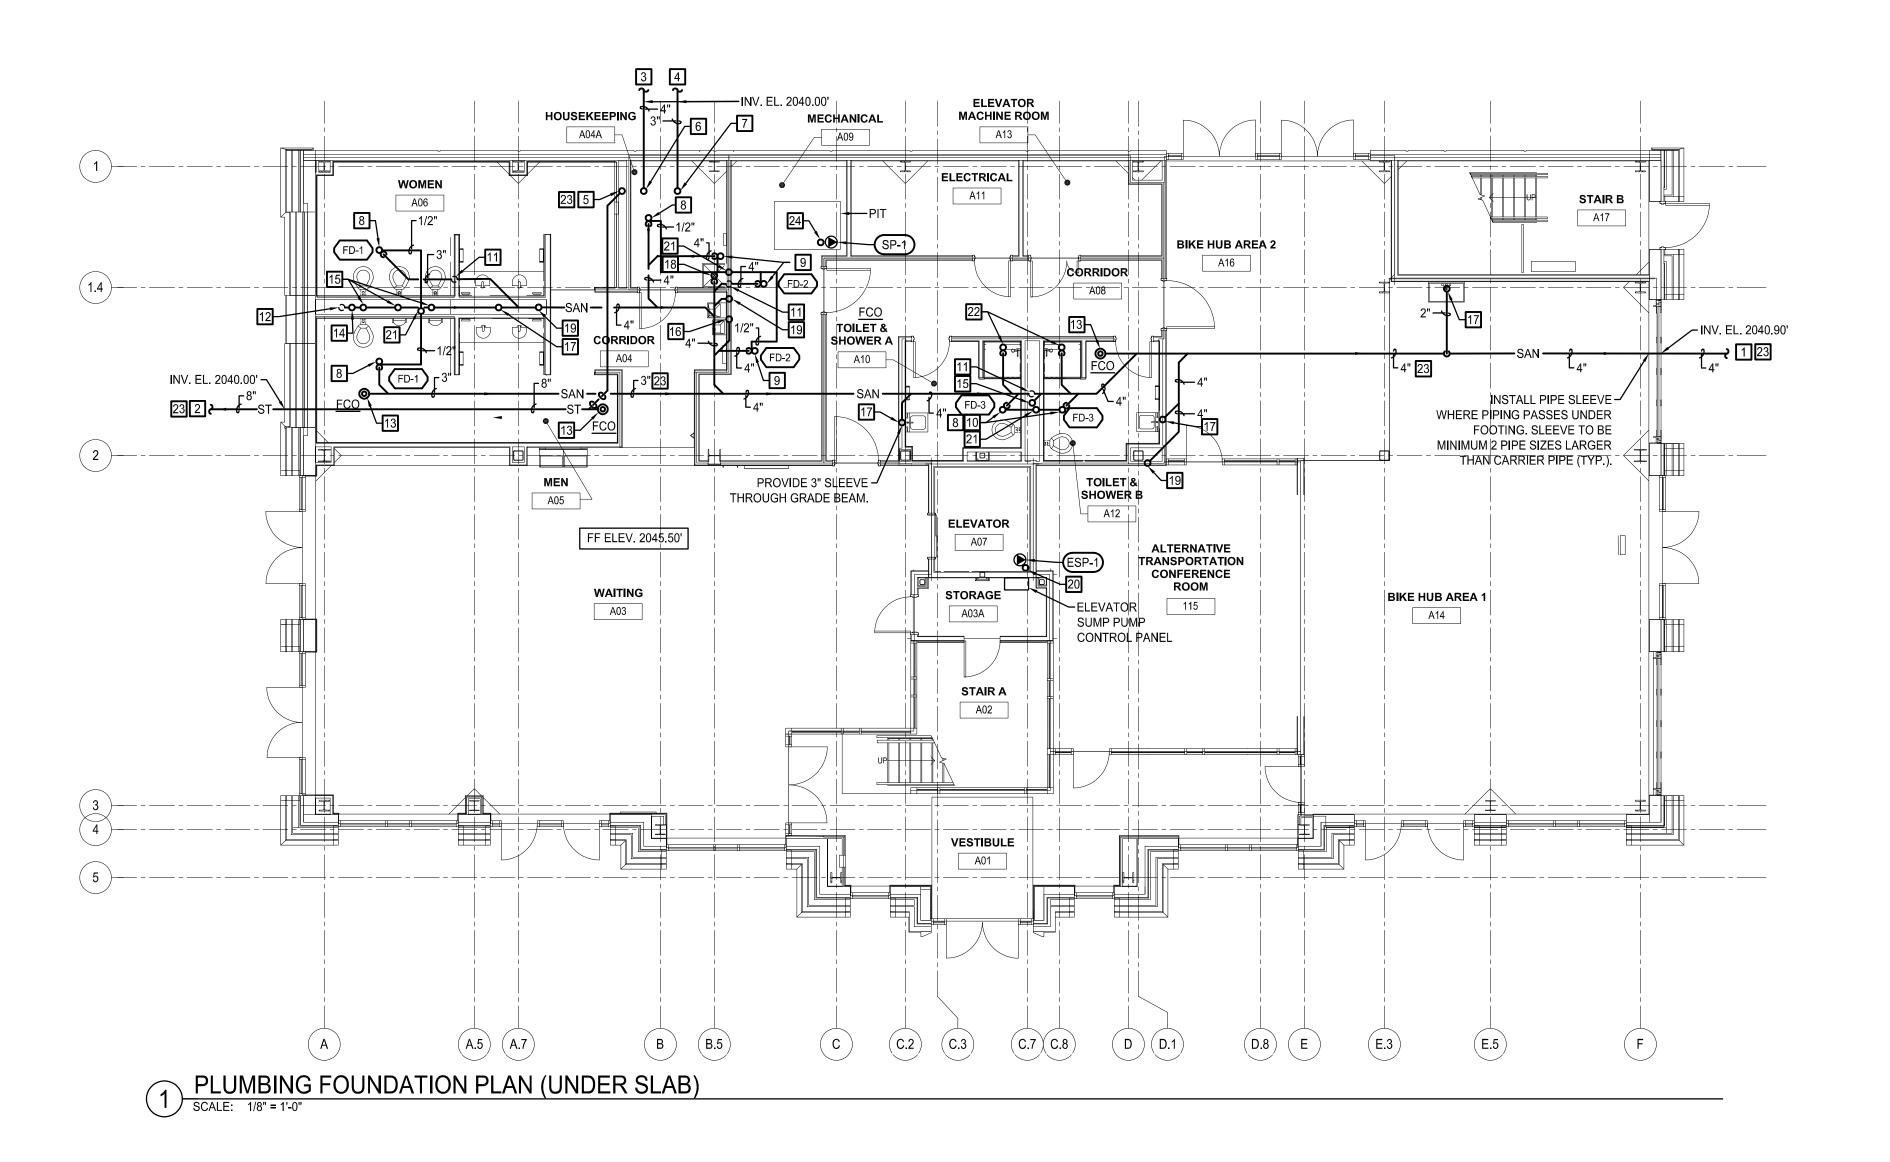

### 

- 1. EXTEND 4" SAN PIPING TO 5'-0" BEYOND BUILDING. REFER TO SITE DRAWINGS FOR CONTINUATION OF
- 2. EXTEND 8"(6,800SF) STORM PIPING TO 5'-0" BEYOND BUILDING. REFER TO CIVIL DRAWINGS FOR CONTINUATION OF PIPING.
- 3. EXTEND 4" DUCTILE IRON FIRE PROTECTION MAIN TO 5'-0" BEYOND BUILDING. REFER TO CIVIL DRAWINGS FOR CONTINUATION OF PIPING.
- 4. EXTEND 3" DOMESTIC WATER DUCTILE IRON MAIN TO 5'-0" BEYOND BUILDING. REFER TO CIVIL DRAWINGS FOR CONTINUATION OF PIPING.
- 5. PROVIDE 8"(6,800SF) STORM PIPING UP.
- 8. PROVIDE 3" SAN PIPING WITH TRAP UP TO FD. REFER TO DETAIL 5/P201.
- 9. PROVIDE 4" SAN PIPING WITH TRAP UP TO FD.
- 10. PROVIDE 2" SAN PIPING WITH TRAP UP TO FD. REFER
- 11. PROVIDE 2" V PIPING UP.
- 12. PROVIDE 3" V PIPING UP.
- 14. PROVIDE 4" SAN PIPING UP TO WCO.
- 15. PROVIDE 4" SAN PIPING UP TO WC.
- 17. PROVIDE 2" SAN PIPING UP TO LAV OR SINK.
- OR MOP SINK.
- 20. PROVIDE 2" PD PIPING FROM ELEVATOR SUMP PIT UP.
- 21. PROVIDE 1/2" CW UP TO TRAP PRIMER VALVE. INSTALL INDIVIDUAL 1/2"CW FROM TRAP PRIMER DISTRIBUTION UNIT TO EACH FLOOR DRAIN CONNECTION.
- 22. PROVIDE 2" SAN PIPING UP TO SHOWER.
- 23. PLUMBING CONTRACTOR TO PROVIDE VIDEO INSPECTION OF ALL UNDERGROUND DRAINAGE PIPING SHOWING CONTINUOUS FALL THROUGHOUT THE SYSTEM. VIDEO DRAINS AFTER FLOOR SLAB INSTALLATION AND TURN VIDEO OVER TO VIRGINIA

- 6. PROVIDE 4" FIRE PROTECTION PIPING UP.
- 7. PROVIDE 3" CW PIPING UP.
- PROVIDE 1/2" CW CONNECTION FOR TRAP PRIMER.
- PROVIDE 1/2" CW CONNECTION FOR TRAP PRIMER. REFER TO DETAIL 5/P201.
- TO DETAIL 5/P201.
- 13. PROVIDE SAN OR STORM PIPING, SIZE AS INDICATED UP TO FCO.
- 16. PROVIDE 2" SAN PIPING UP TO EWC.
- 18. PROVIDE 3" SAN PIPING WITH TRAP UP TO SHOWER
- 19. PROVIDE 4" SAN PIPING UP.

- 24. PROVIDE 1 1/2"PD FROM MECHANICAL PIT UP.

**BUILDING ADDRESS** 1324 PERRY STREET, BLACKSBURG, VA 24060

**MULTI-MODAL TRANSIT** 

**BLACKSBURG TRANSIT** 

**FACILITY** 

**BID SET** 




603 King Street, 4th Floor Alexandria, VA 22314 www.wendelcompanies.com p:703.299.8718 tf:877.293.6335


ARCHITECTURE ● ENGINEERING ● PLANNING ENERGY SERVICES ● CONSTRUCTION MANAGEMENT



DAA Project No. B10172B-05

NOTE:
THIS DOCUMENT, AND THE IDEAS AND DESIGNS INCORPORATED HEREIN, AS AN INSTRUMENT OF PROFESSIONAL SERVICE, IS THE PROPERTY OF THE ARCHITECT AND ENGINEER AND IS NOT TO BE USED IN WHOLE OR IN PART, FOR ARCHITECT AND ENGINEER AND IS NOT TO BE USED IN WHOLE OR IN PART, FOR ANY OTHER PROJECT WITHOUT THE WRITTEN AUTHORIZATION OF THE ARCHITECT AND ENGINEER. UNAUTHORIZED ALTERATION OR ADDITION TO ANY SURVEY DRAWING, DESIGN, SPECIFICATION, PLAN OR REPORT IS PROHIBITED IN ACCORDANCE WITH STATE LAW, CODE AND RULES.

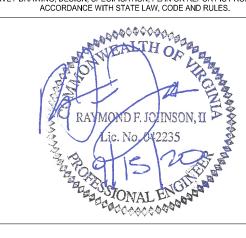

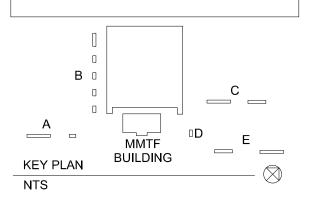


REVISIONS

DWG. TITLE

DWG. No.


PLUMBING FOUNDATION PLAN (UNDER SLAB)

DATE SEPTEMBER 15, 2020 SCALE AS NOTED DWN. TIP снк. CRL PROJ. No. 449803

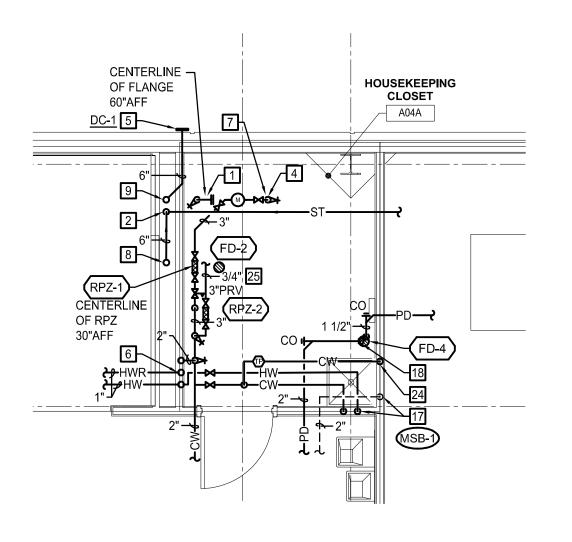


ENLARGED HOUSEKEEPING CLOSET PLUMBING PLAN

SCALE: 1/4" = 1'-0"

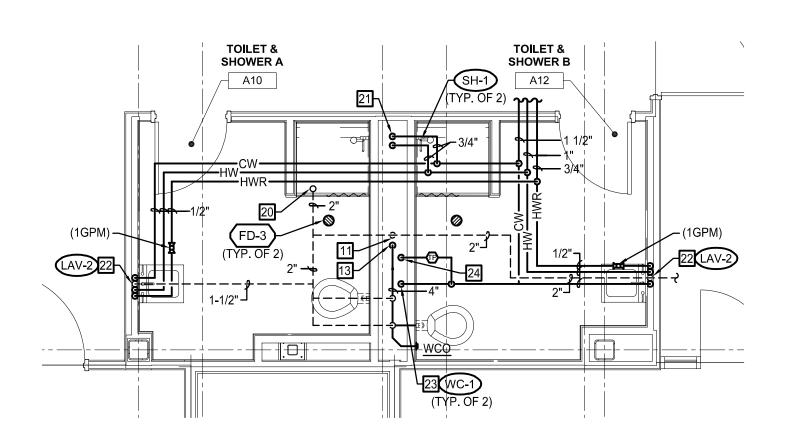

2 ENLARGED TOILET & SHOWER ROOM PLUMBING PLAN
SCALE: 1/4" = 1'-0"

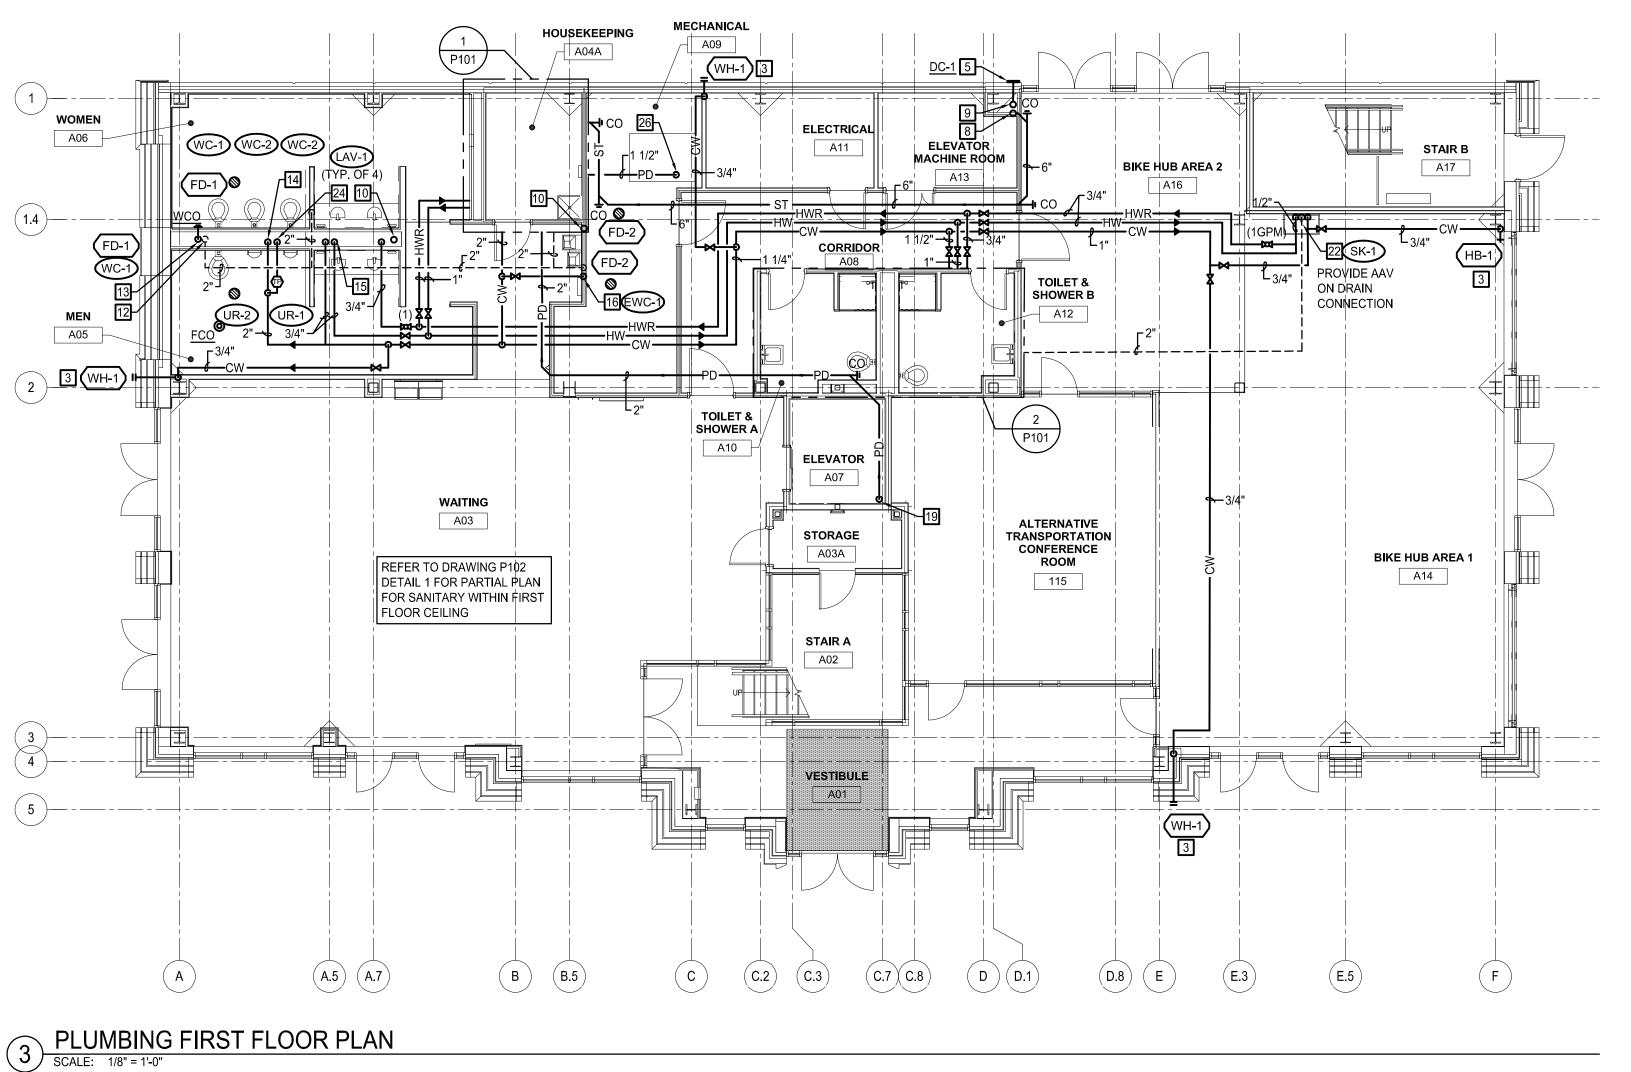

#### ☑ CONSTRUCTION NOTES:

- PROVIDE 4" FIRE PROTECTION PIPING DOWN.
   PROVIDE BLIND FLANGE. REFER TO FIRE PROTECTION DRAWINGS FOR CONTINUATION.
- 2. PROVIDE 6"(6,800SF) ST PIPING DOWN BELOW SLAB. INCREASE TO 8" ST PIPING A.F.F. PROVIDE CLEAN OUT AT 1'-6" A.F.F.
- 3. WALL HYDRANT / HOSE BIBB TO BE MOUNTED 20 INCHES ABOVE GRADE TO CENTERLINE.
- 4. PROVIDE 3" CW FROM BELOW.
- 5. TERMINATE 6" EST PIPING WITH DOWNSPOUT COVER A MINIMUM OR 2'-0" A.F.G. COORDINATE FINAL MOUNTING HEIGHT WITH G.C.
- 6. PROVIDE 2" CW, 1" HWR, 1" HW UP.
- 7. PROVIDE BACKFLOW PREVENTER ASSEMBLY AND WATER METER. REFER TO DETAIL 2/P201.
- 8. PROVIDE 6"(3,400SF) ST PIPING UP.
- 9. PROVIDE 6"(3,400SF) EST PIPING UP.
- 10. PROVIDE 4" SAN PIPING UP AND DOWN.
- 11. PROVIDE 2" V PIPING DOWN.
- 12. PROVIDE 3" V PIPING UP AND DOWN.
- 13. PROVIDE 4" SAN PIPING DOWN. PROVIDE WCO 1'-6" A.F.F.
- 14. PROVIDE 2" CW DOWN TO 2"HEADER FEEDING FLUSH FIXTURES ONLY. INSTALL WATER HAMMER ARRESTOR TYPE "C" ON CW BETWEEN LAST TWO FIXTURES
- 15. PROVIDE 3/4" CW AND 3/4" HW DOWN TO LAVATORIES WITH 1/2"BRANCHES TO EACH FIXTURE. 3/4"HW TO COME BACK OUT OF CHASE AS 3/4"HWR. CONNECT 1/2"HW TO EACH LAV WITHIN 2 FEET OF FAUCET.
- 16. PROVIDE 1/2" CW AND 11/2" V PIPING DOWN TO EWC.
- 17. PROVIDE 1/2" CW&HW, AND 2" V PIPING DOWN TO MSB.
- 18. TERMINATE 2"PD AND 1 1/2"PD PIPING WITH AIR BREAK AT FUNNEL DRAIN.
- 19. PROVIDE 2" PD PIPING DOWN TO ELEVATOR SUMP
- 20. PROVIDE 2" V PIPING UP.
- 21. PROVIDE 3/4" CW & 3/4"HW PIPING DOWN TO SHOWERS.
- 22. PROVIDE 1/2" CW & 3/4"HW AND 2" V PIPING DOWN TO LAV OR SINK. CONNECT 1/2"HWR TO HW WITHIN 2 FEET OF FAUCET.
- 23. PROVIDE 1 1/4" CW DOWN TO WC'S. INSTALL WATER HAMMER ARRESTOR TYPE "B" ON CW BETWEEN THE TWO WATER CLOSET CONNECTIONS.
- 24. PROVIDE 1/2" CW DOWN TO FLOOR DRAIN TRAP PRIMER CONNECTION.
- 25. PROVIDE 3/4"MAKEUP WATER FOR HEATING HOT WATER. CONTINUATION BY HVAC CONTRACTOR.
- 26. PROVIDE 1 1/2" PD PIPING DOWN TO SUMP PUMP.

## **GENERAL NOTES:**

A. DO NOT INSTALL PLUMBING PIPING ABOVE ELECTRICAL PANELS. COORDINATE WITH ALL

## BLACKSBURG TRANSIT

BUILDING ADDRESS 1324 PERRY STREET, BLACKSBURG, VA 24060

## MULTI-MODAL TRANSIT FACILITY

**BID SET** 



603 King Street, 4th Floor Alexandria, VA 22314 www.wendelcompanies.com p:703.299.8718 tf:877.293.6335

ARCHITECTURE ● ENGINEERING ● PLANNING ENERGY SERVICES ● CONSTRUCTION MANAGEMENT





Blacksburg, VA 24060 www.daa.com


DAA Project No. B10172B-05

NOTE:

THIS DOCUMENT, AND THE IDEAS AND DESIGNS INCORPORATED HEREIN, AS AN INSTRUMENT OF PROFESSIONAL SERVICE, IS THE PROPERTY OF THE ARCHITECT AND ENGINEER AND IS NOT TO BE USED IN WHOLE OR IN PART, FOR ANY OTHER PROJECT WITHOUT THE WRITTEN AUTHORIZATION OF THE ARCHITECT AND ENGINEER. UNAUTHORIZED ALTERATION OR ADDITION TO ANY SURVEY DRAWING, DESIGN, SPECIFICATION, PLAN OR REPORT IS PROHIBITED IN ACCORDANCE WITH STATE LAW, CODE AND RULES.

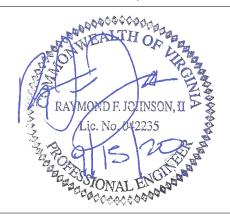

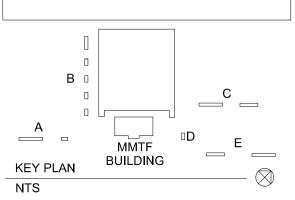

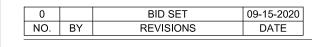

DWG. TITLE

PLUMBING FIRST FLOOR PLAN


DATE SEPTEMBER 15, 2020


SCALE AS NOTED


DWN. TIP CHK. CRL

DWN. TIP
PROJ. No. 449803

DWG. No.

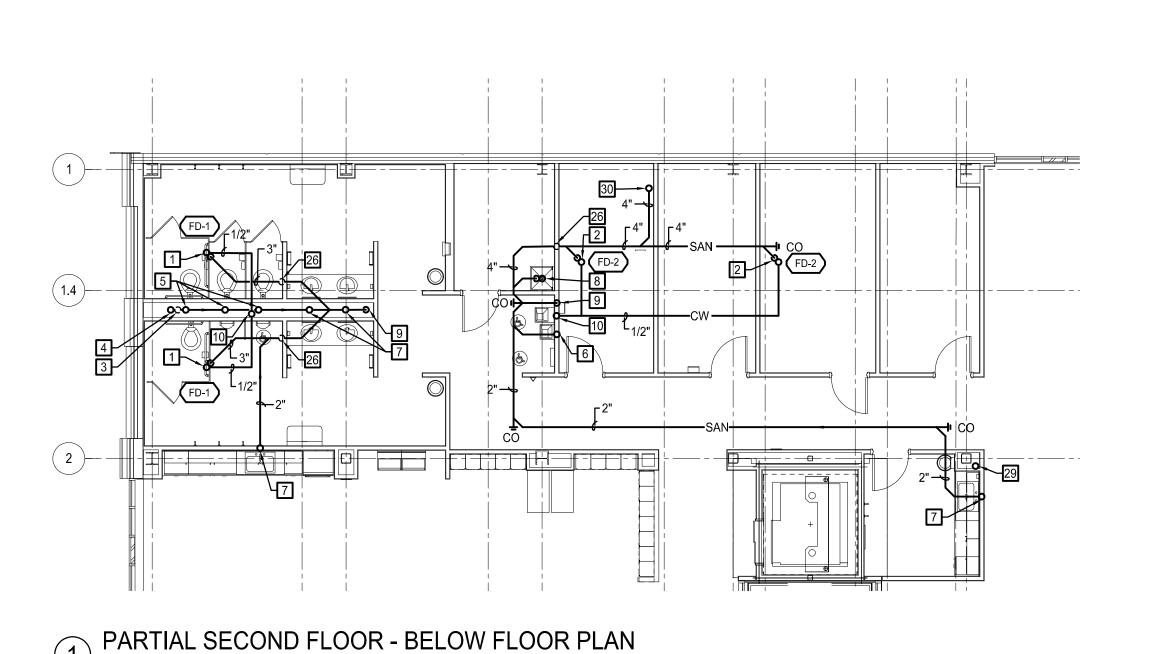

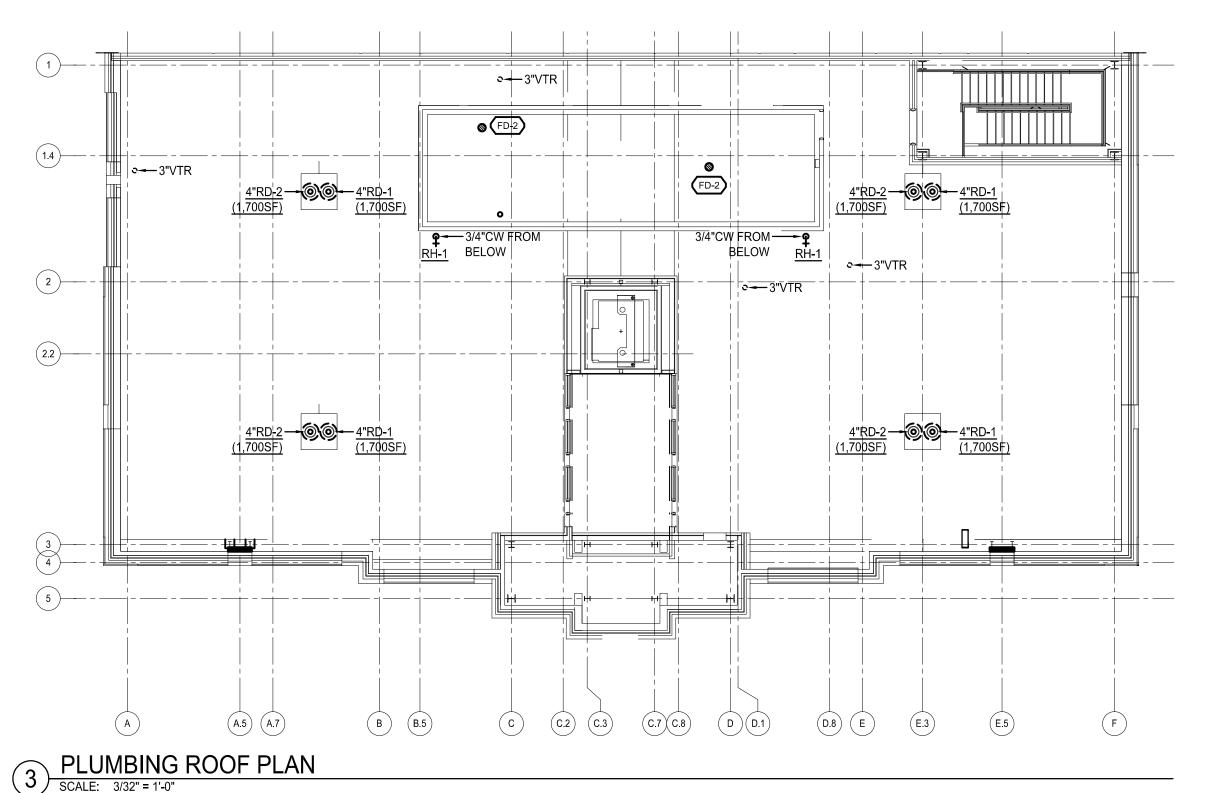

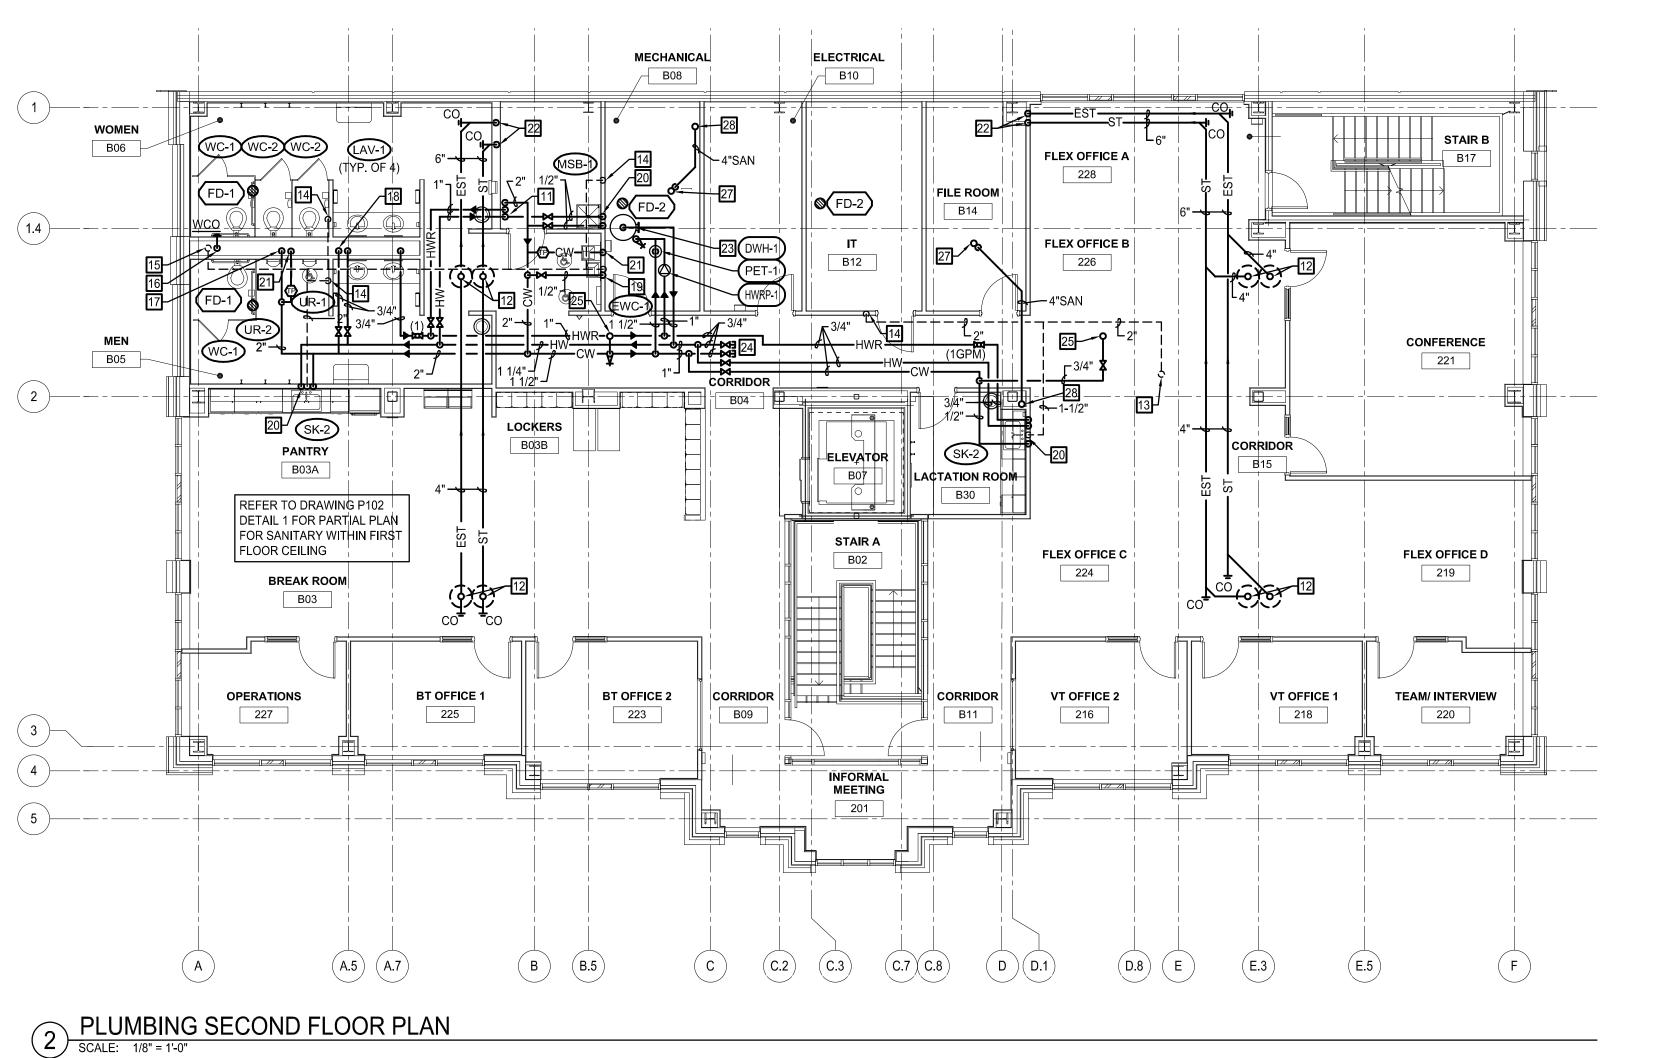

### 

- 1. PROVIDE 3" SAN PIPING WITH TRAP UP TO FD. REFER TO DETAIL 6/P201.
- 2. PROVIDE 4" SAN PIPING WITH TRAP UP TO FD.
- 3. PROVIDE 3" V PIPING UP AND DOWN.
- 4. PROVIDE 4" SAN PIPING UP TO WCO.

REFER TO DETAIL 6/P-201.

- 5. PROVIDE 4" SAN PIPING UP TO WC.
- 6. PROVIDE 2" SAN PIPING UP TO EWC.
- 7. PROVIDE 2" SAN PIPING UP TO LAV / SINK.
- 8. PROVIDE 3" SAN PIPING WITH TRAP UP TO MSB.
- 9. PROVIDE 4" SAN PIPING DOWN.
- 10. PROVIDE 1/2" CW UP TO TRAP PRIMER VALVE. INSTALL INDIVIDUAL 1/2"CW FROM TRAP PRIMER DISTRIBUTION UNIT (WHERE APPLICABLE) TO EACH FLOOR DRAIN CONNECTION.
- 11. PROVIDE 2" CW, 1" HWR, AND 1" HW DOWN.
- 12. PROVIDE 4" ST/EST PIPING UP TO ROOF DRAIN. REFER TO ROOF PLAN DETAIL 3 ON P102.
- 13. PROVIDE 2" V PIPING UP TO 3" VTR. REFER TO ROOF PLAN DETAIL 3 ON P102.
- 14. PROVIDE 2" V PIPING DOWN.
- 15. PROVIDE 3" V PIPING UP AND DOWN..
- 16. PROVIDE 4" SAN PIPING DOWN. PROVIDE WCO 1'-6" A.F.F.
- 17. PROVIDE 2" CW DOWN TO 2"HEADER FEEDING FLUSH FIXTURES ONLY. INSTALL WATER HAMMER ARRESTOR TYPE "C" ON CW PIPE BETWEEN LAST TWO FIXTURES.
- 18. PROVIDE 3/4" CW AND 3/4" HW DOWN TO LAVATORIES.PROVIDE 3/4" CW AND 3/4" HW DOWN TO LAVATORIES WITH 1/2"BRANCHES TO EACH FIXTURE. 3/4"HW TO COME BACK OUT OF CHASE AS 3/4"HWR. CONNECT 1/2"HW TO EACH LAV WITHIN 2 FEET OF FAUCET.
- 19. PROVIDE 1/2" CW AND 1 1/2" V PIPING DOWN TO EWC.
- 20. PROVIDE 1/2" CW & 3/4"HW, AND 2" V PIPING DOWN TO SINK. CONNECT 3/4"HWR TO HW WITHIN TWO FEET OF THE FAUCET.
- 21. PROVIDE 1/2" CW DOWN TO FLOOR DRAIN TRAP PRIMER CONNECTION.
- 22. PROVIDE 6" ST/EST PIPING DOWN.
- 23. PROVIDE DOMESTIC WATER HEATER AND ASSOCIATED EQUIPMENT AND PIPING. REFER TO DETAIL 1/P201.
- FOR FUTURE CONNECTION.

24. PROVIDE 3/4" CW&HW PIPING VALVED AND CAPPED

- 25. PROVIDE 3/4" CW UP TO ROOF HYDRANT. REFER TO ROOF PLAN 3 ON P102.
- 26. PROVIDE 2" V PIPING UP.
- 27. PROVIDE 4" SANITARY FROM FLOOR DRAIN ABOVE.
- 28. PROVIDE 4" SANITARY DOWN, 2"VENT UP, AND 3"VTR.
- 29. 4" SANITARY UP AND DOWN
- 30. 4" SANITARY UP

- 1324 PERRY STREET, BLACKSBURG, VA 24060 PROVIDE 1/2" CW CONNECTION FOR TRAP PRIMER.
- **MULTI-MODAL TRANSIT FACILITY** PROVIDE 1/2" CW CONNECTION FOR TRAP PRIMER.
  - **BID SET**

**BLACKSBURG TRANSIT** 

**BUILDING ADDRESS** 





Alexandria, VA 22314 www.wendelcompanies.com p:703.299.8718 tf:877.293.6335 ARCHITECTURE ● ENGINEERING ● PLANNING ENERGY SERVICES ● CONSTRUCTION MANAGEMENT




2206 South Main Street 540-552-0444 Blacksburg, VA 24060 www.daa.com DAA Project No. B10172B-05

NOTE:
THIS DOCUMENT, AND THE IDEAS AND DESIGNS INCORPORATED HEREIN, AS AN
INSTRUMENT OF PROFESSIONAL SERVICE, IS THE PROPERTY OF THE
ARCHITECT AND ENGINEER AND IS NOT TO BE USED IN WHOLE OR IN PART, FOR ARCHITECT AND ENGINEER AND IS NOT TO BE USED IN WHOLE OR IN PART, FOR ANY OTHER PROJECT WITHOUT THE WRITTEN AUTHORIZATION OF THE ARCHITECT AND ENGINEER. UNAUTHORIZED ALTERATION OR ADDITION TO ANY SURVEY DRAWING, DESIGN, SPECIFICATION, PLAN OR REPORT IS PROHIBITED IN ACCORDANCE WITH STATE LAW, CODE AND RULES.

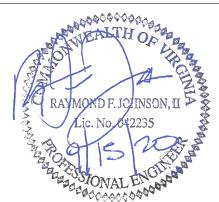

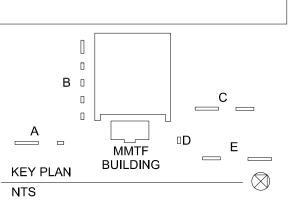

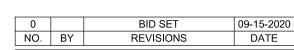


DWG. TITLE


**PLUMBING** SECOND FLOOR AND ROOF PLANS

DATE SEPTEMBER 15, 2020 SCALE AS NOTED DWN. TIP снк. CRL

DWG. No. P102

PROJ. No. 449803

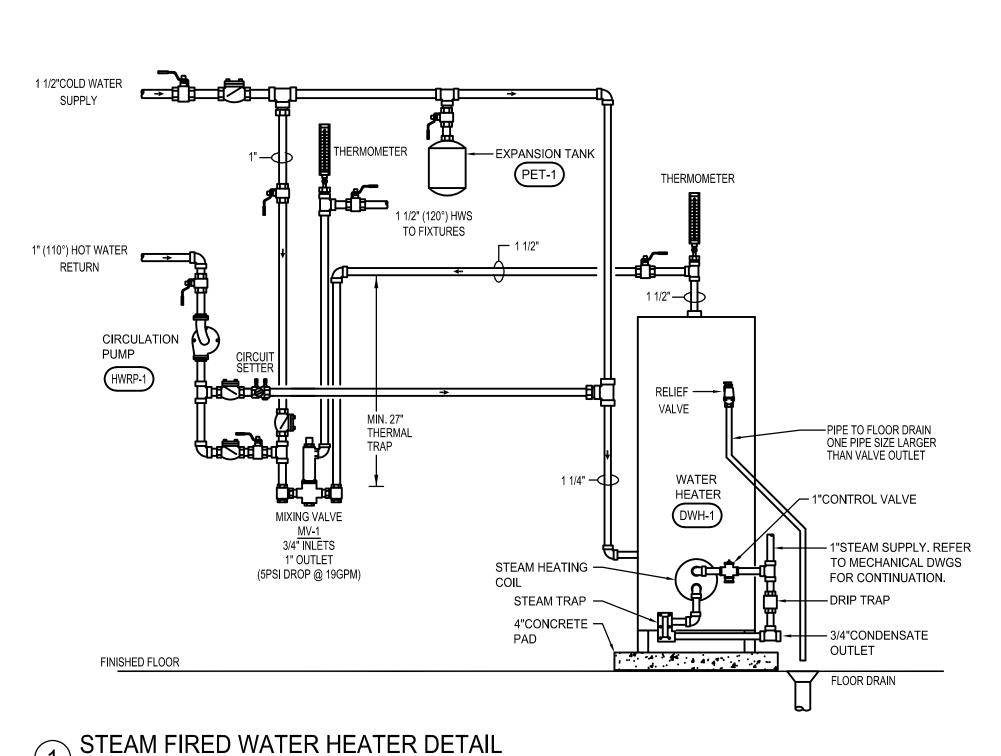

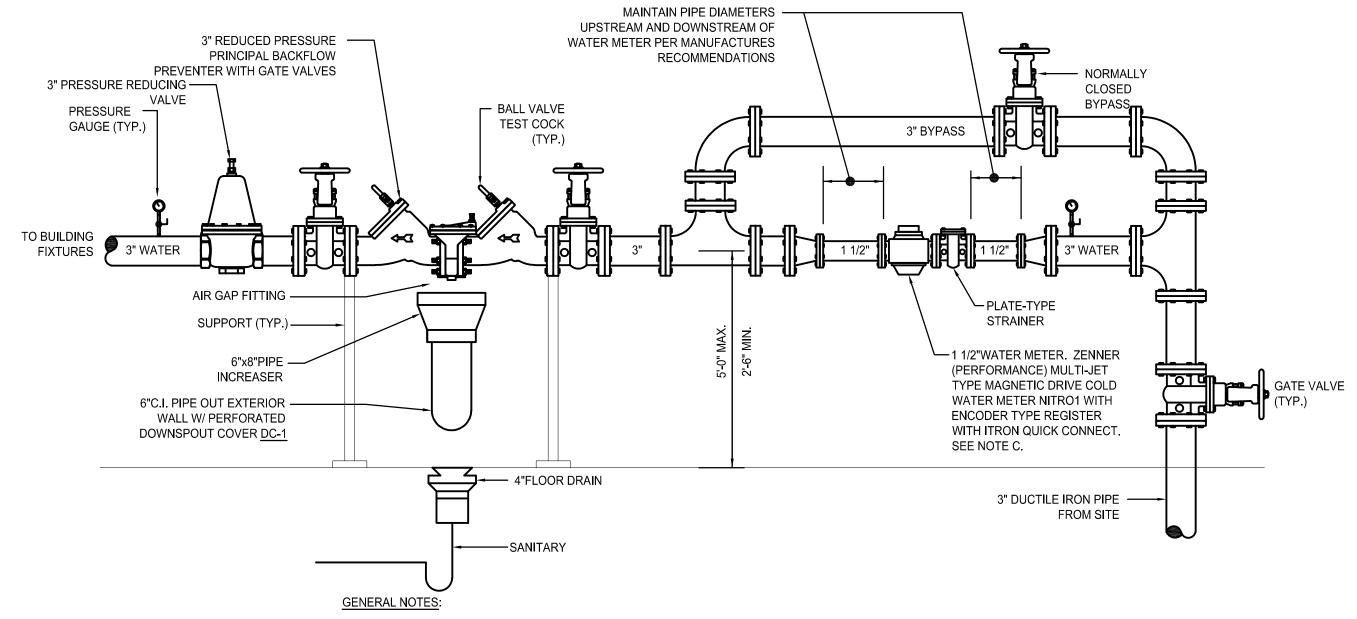

A. MAINTAIN CODE REQUIRED AND MANUFACTURER'S RECOMMENDED CLEARANCES BETWEEN VALVE ASSEMBLIES AND WALLS OR OTHER OBSTRUCTIONS. COORDINATE LOCATION SHOWN ON PLAN WITH INSTALLED CONDITIONS.

1. A MINIMUM OF 1'-0" OF CLEAR SPACE SHALL BE MAINTAINED ABOVE THE ASSEMBLY TO ALLOW FOR SERVICING CHECK VALVES.

2. A MINIMUM OF 2'-6" OF CLEAR SPACE SHALL BE MAINTAINED BETWEEN THE FRONT SIDE OF THE DEVICE AND THE NEAREST WALL OR OBSTRUCTION.

3. A MINIMUM OF 0'-8" OF CLEAR SPACE SHALL BE MAINTAINED FROM THE BACK SIDE OF THE DEVICE TO THE NEAREST WALL OR OBSTRUCTION. THIS CLEARANCE MAY NEED TO BE INCREASED

60W WITH AN INLINE CONNECTOR, PART #ERW-0771-202, UTILITY ID#181 FOR VIRGINIA POLYTECHNIC

FOR MODELS THAT HAVE SIDE MOUNTED TEST COCKS OR RELIEF VALVES THAT FACE THE BACK WALL.


B. FOLLOW MANUFACTURER'S INSTALLATION INSTRUCTIONS EXPLICITLY.

C. METER SHALL HAVE AN ITRON ENCODER FOR ZENNER (PERFORMANCE) METERS. ENCODER SHALL BE AN ITRON

INSTITUTE
D. REFER TO SPECIFICATION SECTION 221119.

WATER SERVICE DETAIL

SCALE: NONE

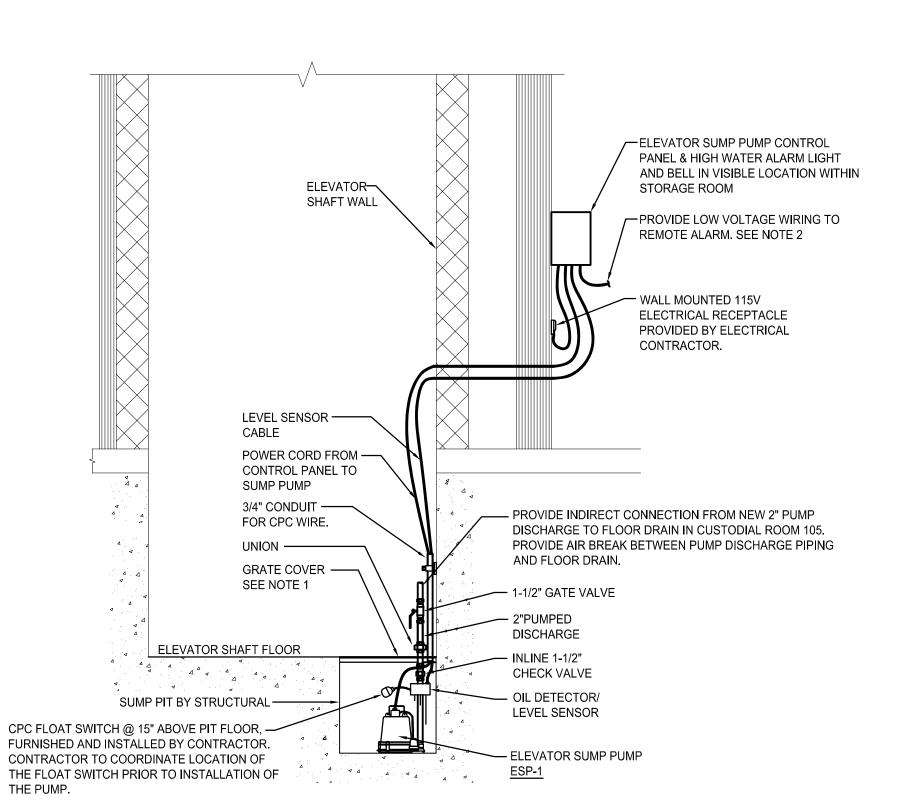


SCALE: NONE


#### NOTES:

- 1. COVER SHALL BE FABRICATED OF 1/4" THICK GALVANIZED STEEL DIAMOND PLATE FLUSH WITH ELEVATOR SHAFT FLOOR. WELD 3"x3"x1/4" GALVANIZED STEEL ANGLES TO TWO SIDES OF DIAMOND PLATE. HOT DIPPED AFTER FABRICATION. NOTCH OUT COVER TO ALLOW FOR PIPE RISER ANS WATER TO ENTER PIT. CONTRACTOR SHALL FIELD VERIFY SUMP PIT DIMENSIONS.
- 2. PROVIDE LOW VOLTAGE WIRING FROM ELEVATOR SUMP PUMP CONTROLLER TO REMOTE ALARM IN CUSTODIAL ROOM 110. PROVIDE POWER TO REMOTE ALARM FROM WALL MOUNTED 115V ELECTRICAL RECEPTACLE. PROVIDE LOW VOLTAGE WIRING FROM REMOTE ALARM TO BMS SYSTEM.



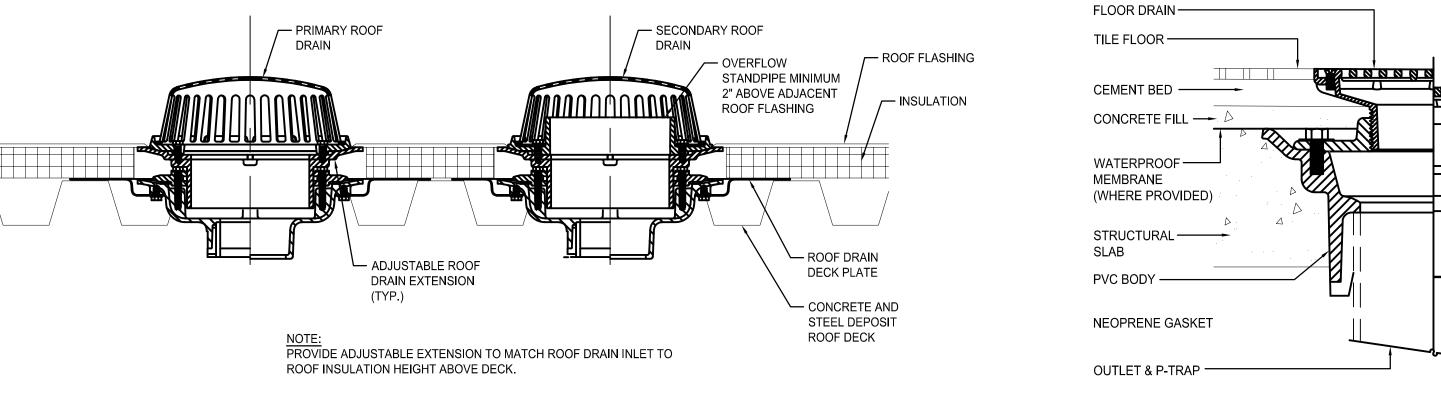

4 COMBINATION PRIMARY/SECONDARY ROOF DRAIN INSTALLATION DETAIL SCALE: NONE

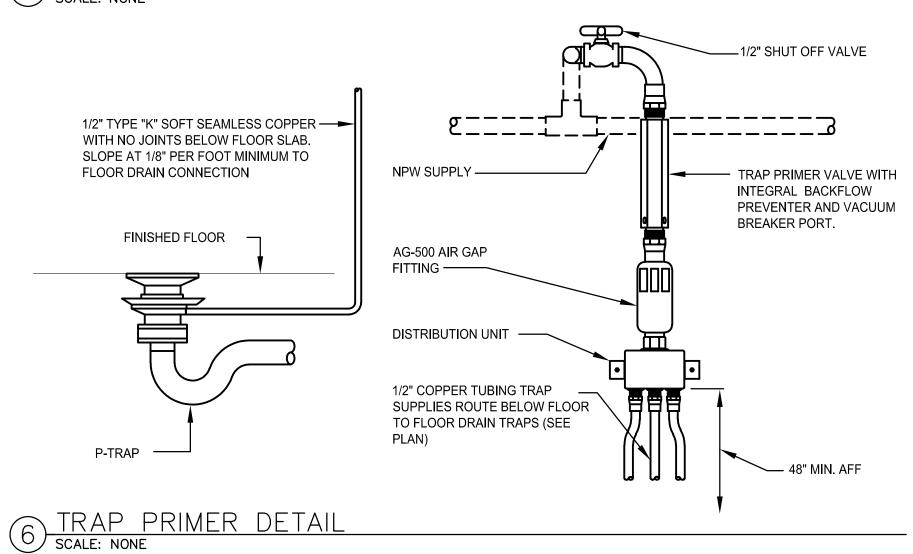

AQUASTAT FOR CONTROL
OF PUMP (SEE PUMP SCHEDULE)

THERMOMETER

PLUG VALVE (TYPICAL)

FOR CONTINUATION AND SIZE, SEE FLOOR PLAN

FOR INSERTION OF GAUGE)

UNION OR FLANGE
CONNECTION

7 IN-LINE CIRCULATING PUMP DETAIL
SCALE: NONE

5 FLOOR DRAIN DETAIL
SCALE: NONE

#### **BLACKSBURG TRANSIT**

BUILDING ADDRESS 1324 PERRY STREET, BLACKSBURG, VA 24060

MULTI-MODAL TRANSIT FACILITY

BID SET



p:703.299.8718 tf:877.293.6335

ARCHITECTURE • ENGINEERING • PLANNING ENERGY SERVICES • CONSTRUCTION MANAGEMENT


www.wendelcompanies.com



2206 South Main Street 540-552-0444 Blacksburg, VA 24060 www.daa.com DAA Project No. B10172B-05

THIS DOCUMENT, AND THE IDEAS AND DESIGNS INCORPORATED HEREIN, AS AN INSTRUMENT OF PROFESSIONAL SERVICE, IS THE PROPERTY OF THE ARCHITECT AND ENGINEER AND IS NOT TO BE USED IN WHOLE OR IN PART, FOR ANY OTHER PROJECT WITHOUT THE WRITTEN AUTHORIZATION OF THE ARCHITECT AND ENGINEER. UNAUTHORIZED ALTERATION OR ADDITION TO ANY SURVEY DRAWING, DESIGN, SPECIFICATION, PLAN OR REPORT IS PROHIBITED IN



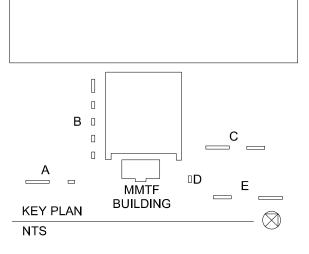

0		BID SET	09-15-2020
NO.	BY	REVISIONS	DATE
		I.	•

DWG. TITLE

PRIMER

TAPPING.

PLUMBING DETAILS


DATE SEPTEMBER 15, 2020


SCALE AS NOTED

DWN. TIP CHK. CRL


PROJ. No. 449803

DWG. No.

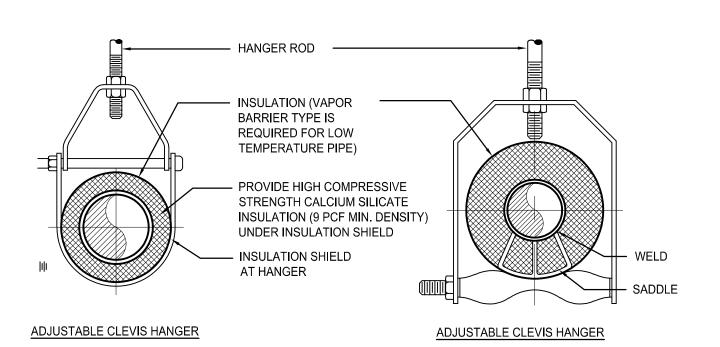

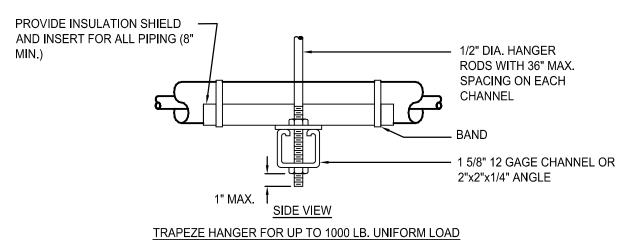



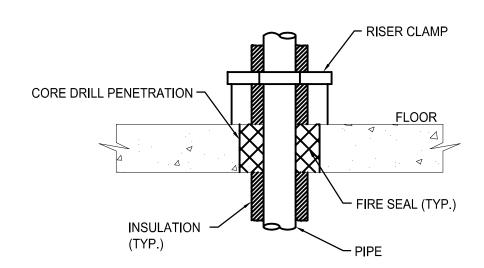


NOTE:

1. PROVIDE SLEEVE 2 PIPE SIZES LARGER THAN PIPE. 2.


MOUNT SLEEVE FLUSH TO BOTH SIDES OF SLAB.

2. EXTEND SLEEVE TWO INCHES ABOVE FLOOR IN MECHANICAL ROOMS FOR A WATER STOP.


# 5 FLOOR PENETRATION DETAIL SCALE: NOT TO SCALE

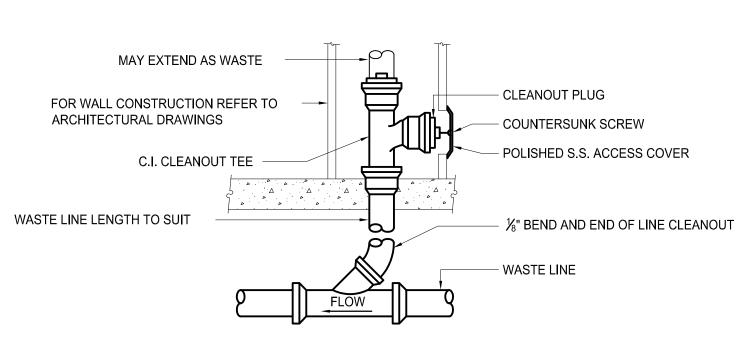



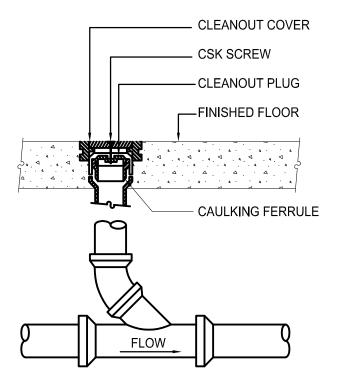

3 FLOOR CLEANOUT DETAIL
SCALE: NOT TO SCALE

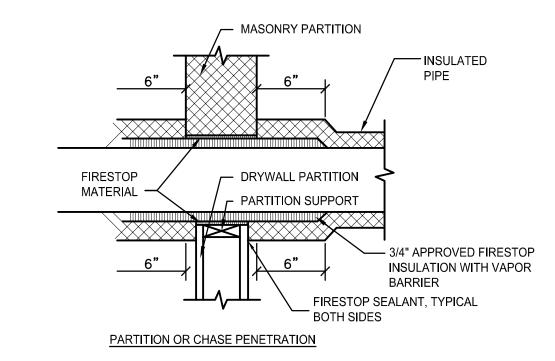

NOTE:

1. WHERE WALL IS NOT FIRE RATED PIPE INSULATION SHOULD CONTINUE THROUGH SLEEVE OPENING AND GROUT SPACE BETWEEN OUTSIDE OF INSULATION AND INSIDE OF SLEEVE.

# WALL PIPE PENETRATION DETAIL (FOR FIRE RATED AND NON RATED WALLS) SCALE: NOT TO SCALE

#### **BLACKSBURG TRANSIT**

BUILDING ADDRESS 1324 PERRY STREET, BLACKSBURG, VA 24060

# MULTI-MODAL TRANSIT FACILITY


**BID SET** 







2206 South Main Street 540-552-0444 Blacksburg, VA 24060 www.daa.com

NOTE:
THIS DOCUMENT, AND THE IDEAS AND DESIGNS INCORPORATED HEREIN, AS AN INSTRUMENT OF PROFESSIONAL SERVICE, IS THE PROPERTY OF THE ARCHITECT AND ENGINEER AND IS NOT TO BE USED IN WHOLE OR IN PART, FOR ANY OTHER PROJECT WITHOUT THE WRITTEN AUTHORIZATION OF THE ARCHITECT AND ENGINEER. UNAUTHORIZED ALTERATION OR ADDITION TO ANY SURVEY DRAWING, DESIGN, SPECIFICATION, PLAN OR REPORT IS PROHIBITED IN ACCORDANCE WITH STATE LAW, CODE AND RULES.

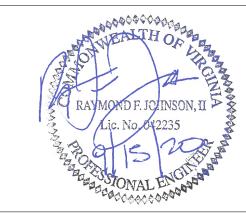

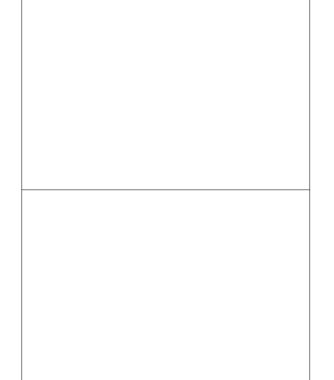

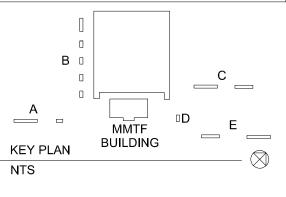

0		BID SET	09-15-2020
NO.	BY	REVISIONS	DATE

DWG. TITLE

PLUMBING DETAILS

DATE SEPTEMBER 15, 2020

SCALE AS NOTED

DWN. TIP CHK. CRL

PROJ. No. 449803

DWG. No.

	HOT WATER RETURN PUMP SCHEDULE (HWRP)												
PLAN DESIGNATION	MANUFACTURER MODEL NO.	SERVICE	LOCATION	TEMPERATURE (DEG. °F)	TOTAL HEAD (FT)	FLOW (GPM)	(UD)	RPM	ELECTRICAL DATA				NOTES
									VOLTS	PHASE	HERTZ	F.L.AMPS	
HWRP-1	TACO 008-BC6	DOMESTIC WATER	MECH ROOM	120	12	6	1/25	3250	115	1	60	0.84	1,2,3

- BRONZE BODY CONSTRUCTION, NON FERROUS IMPELLER, 225°F MAX OPERATING TEMPERATURE, 125 PSI MAX WORKING PRESSURE.
- PROVIDE AQUASTAT AND AUTOMATIC TIMER KIT.
- PROVIDE THERMAL ELECTRICAL DISCONNECT.

	PLUMBING EXPANSION TANK SCHEDULE (PET)										
PLAN DESIGNATION MANUFACTURER MODEL NO. LOCATION TANK TYPE VOLUME (GAL.) ACCEPTANCE VOLUME (IN.) DIAMETER (IN.) DIAMETER (IN.) FULL WEIGHT (LBS) NOTES									NOTES		
PET-1	WILKINS WTTA-12	MECH. ROOM O&M BLDG	BLADDER	5	3.3	14	12	3/4	28	ASME RATED	

ST	STEAM FIRED DOMESTIC WATER HEATER WITH ELECTRIC BACKUP SCHEDULE (DWH)										
PLAN	MANUFACTURER			STORAGE	STEAM INLET	GPH RECOVERY	CONTROL	ELECTRICAL DATA			
DESIGNATION	MODEL NO.	TYPE	LOCATION I STATE I STATE I		@ 100° F	VALVE SIZE	KW	VOLTS/ PHASE	HERTZ	NOTES	
DWH-1	HUBBELL MODEL PS80SLD5-20T4	TANK, CEMENT LINED	MECH RM	80	5	118	1"	20	480/3	60	1

#### NOTES:

- 1. PROVIDE THE FOLLOWING STANDARD AND OPTIONAL EQUIPMENT: -ELECTRIC BACKUP HEATING COIL
  - -COMBINATION TEMPERATURE AND PRESSURE GAUGE -DOUBLE WALL COPPER TUBE HEATING COIL
  - -SOLENOID SAFETY SYSTEM WHICH CLOSES STEAM SUPPLY IF OVERHEATING
  - OCCURS -ASME PRESSURE/TEMPERATURE RELIEF VALVE
  - -STEAM PRESSURE REDUCING VALVE
  - -F&T STEAM TRAP WITH STRAINER -ELECTRIC DISCONNECT SWTTCH
  - FACTORY APPLIED INSULATED JACKET

- 2. PROVIDE PLASTIC LAMINATED SIGN STATING: WARNING WATER HEATER HAS ELECTRIC HEATING ELEMENT. DISCONNECT POWER PRIOR TO DRAINING OR WORKING ON HEATER. ATTACH SIGN TO WATER HEATER IN VISIBLE LOCATION.
- SET WATER HEATER AT AN ELEVATION THAT WILL ALLOW STEAM CONDENSATE TO RETURN TO THE CONDENSATE TANK.

	ELEVATOR SUMP PUMP SCHEDULE (ESP)										
DESIGNATION	MANUFACTURER MODEL NO	SERVICE	CAPACITY	TOTAL HEAD	HP	RPM	ELECT	TRICAL DA	ΛTA		NOTES
	MODEL NO.		(GPM)	(FT)			VOLTS	PHASE	AMPS	HERTZ	
ESP-1	LIBERTY ELV290	ELEVATOR PIT	50	20	3/4	3450	115	1	10.4	60	1-4

#### 1. SUMP PUMP SHALL HAVE OIL MINDER CONTROLS FEATURING:

- NEMA 4X WEATHERTIGHT ENCLOSURE
- STAINLESS STEEL SENSOR PROBE
- SINGLE DIRECT PLUG-IN SOURCE ALARM, LIGHT, AND CONTROL PANEL CIRCUIT (CPC)
- 2. INSTALL PER MANUFACTURES INSTRUCTIONS. 3. TIE CONTROLS INTO BMS SYSTEM. 4. PROVIDE ALL WIRING REQUIRED FOR OPERATION.

	SUMP	PUMP S	CHEDU	LE (S	P)						
DESIGNATION	MANUFACTURER MODEL NO.	SERVICE I CAPACITY I LIFAD			HP	RPM	ELECTRICAL DATA				NOTES
			(01 111)	(FT)			VOLTS	PHASE	AMPS	HERTZ	
SP-1	LIBERTY HT41A-2	MECHANICAL ROOM PIT	10	15	4/10	3450	115	1	12	60	1-4

- 1. SUMP PUMP RATED FOR WATER TEMPERAURES UP TO 200°F.
- 2. PROVIDE FLOAT WITH PIGGY BACK SWITCH AND 25 FOOT CORD.
- 3. INSTALL PER MANUFACTURES INSTRUCTIONS. 4. PROVIDE PLUG-IN TYPE HIGH WATER ALARM SUMP ALARM MODEL SA-120V-2L16F WITH 16 FOOT CORD.

	PL	UMBING FIXTURE	E / SF	PECIA	LTY S	SCHE	DULE		
FIXTURE NO.	DESCRIPTION	MANUFACTURER & MODEL	S/W	IPING CO VENT	NNECTION C.W.	IS H.W.	ACCESSORIES	REMARKS	
DC-1	DOWNSPOUT COVER (AT EMERGENCY OVERFLOW DRAIN OUTLETS), STAINLESS STEEL, PERFORATED HINGED COVER, FLUSH TO WALL	MIFAB R1960-F	-	-	-	-	-	-	
EWC-1	ADA COMPLIANT, BI-LEVEL ELECTRIC WATER COOLER WITH FILTERED BOTTLE FILLING STATION, #14 GAUGE TYPE 304 SS	ELKAY EZH20 LZSTL8WSSP	2"	1-1/2"	1/2"	-	WALL MOUNTING PLATE, VANDAL RESISTANT BUBBLER, 3 PACK REPLACEMENT FILTERS	115V, 4.2 AMP, PLUG IN TO DUAL OUTLET	
FCO	FLOOR CLEAN OUT W/ ROUND ADJUSTABLE NICKEL BRONZE TOP & SECONDARY PLUG	MIFAB C1100-R	VARIES	-	-	-		SIZE TO MATCH SANITARY LINE SIZE, MAXIMUM 4"	
FD-1	FLOOR DRAIN, 6"Ø NICKEL BRONZE STRAINER, TRAP PRIMER CONNECTION	MIFAB F1100-7-1	VARIES	-	-	-	TRAP PRIMER	-	
FD-2	FLOOR DRAIN, 7"Ø DUCTILE IRON STRAINER AND SEDIMENT BUCKET TRAP PRIMER CONNECTION	MIFAB F1300C-5-7	VARIES	ı	-	-	TRAP PRIMER	-	
FD-3	FLOOR DRAIN, 5"Ø STAINLESS STEEL STRAINER, TRAP PRIMER CONNECTION	MIFAB F1000-C-3-7	2"	-	-	-	TRAP PRIMER	-	
FD-4	FLOOR DRAIN, 5"Ø HUB OPENING FOR ELEVATOR PUMPED DISCHARGE, TRAP PRIMER CONNECTION	MIFAB F1000-C-DD	4"	-	-	-	TRAP PRIMER	-	
HB-1	HOSE BIBB, ROUGH BRASS FINISH, ANTI-SIPHON VACUUM BREAKER, CAST IRON WHEEL	MIFAB MHY-9041	-	-	3/4"	-	-	-	
LAV-1	OVAL LAVATORY, VITREOUS CHINA, DROP-IN, OVERFLOW, SINGLE FAUCET HOLE, 20 1/8"x16 1/2"WIDE	KOHLER K-2699	2"	1-1/2"	1/2"	1/2"	FAUCETS, THERMOSTATIC MIXING VALVE (ASSE 1070), SS STRAINER, SUPPLIES, STOPS, TRAP, OFFSET TAILPIECE ESCUTCHEON PLATE	SENSOR FAUCET, WATER TURBINE POWERED W/ CONTROLLER FOR 0.09GPC, TOTO MODEL TEL105-D10E. TMV TOTO MODEL TLM10	
LAV-2	ADA COMPLIANT WALL MOUNTED LAVATORY, VITREOUS CHINA, OVERFLOW, SINGLE HOLE CENTER, 20 3/4"x18 1/4"WIDE	KOHLER K-2032	2"	1-1/2"	1/2"	1/2"	FAUCETS, THERMOSTATIC MIXING VALVE (ASSE 1070), SS STRAINER, SUPPLIES, STOPS, TRAP, OFFSET TAILPIECE ESCUTCHEON PLATE	SENSOR FAUCET, WATER TURBINE POWERED W/ CONTROLLER FOR 0.09GPC, TOTO MODEL TEL105-D10E. TMV TOTO MODEL TLM10	
MSB-1	MOP SINK FLOOR MOUNTED, TERRAZZO 24"x24"x6"	FIAT SB2424	3"	1-1/2"	1/2"	1/2"	FAUCET, HOSE AND HOSE BRACKET	TWO LEVER FAUCET W/ INTERNAL STOPS AND VACUUM BREAKER, CHICAGO MODEL 445-897SRCXKCP	
PRV-1	PRESSURE REDUCING VALVE, LEAD FREE, STRAINER, PORTS FOR LOW FLOW BYPASS, LOW FLOW PRESSURE REGULATOR	HIGH FLOW: WATTS 3" LFN223FS LOW FLOW: WATTS 3/4" LF223	-	-	3"	-	-	PROVIDE PIPE AND FITTINGS WITH SHUTOFFS FOR 3/4" LOW FLOW BYPASS. PRESSURE SETTING TO 50 PSI.	
RD-1	ROOF DRAIN, CAST IRON BODY AND DOME, DECK CLAMP AND MOUNTING PLATE	FROET 200C-DC-DMP	-	-	-	-	-	REFER TO ROOF PLAN	
RD-2	ROOF DRAIN, CAST IRON BODY AND DOME, DECK CLAMP AND MOUNTING PLATE, 2"OVERFLOW DAM	FROET 200C-DMP-WD2	-	-	-	-	-	REFER TO ROOF PLAN	
RH-1	ROOF HYDRANT, FREEZE PROOF,CAST IRON HEAD AND HANDLE, GALVANIZED STEEL CASING, ROOF SUPPORT SLEEVE, ANCHORING FLANGE AND CLAMP COLLAR, VACUUM BREAKER. 1/8"DRAIN PORT	ZURN Z1388-VB						PROVIDE 1/8"TUBING FROM DRAIN PORT OPEN ENDED TO MOP RECEPTOR	
RPZ-1	REDUCED PRESSURE ZONE BACKFLOW PREVENTER W/ QUARTER TURN BALL VALVES, LEAD FREE (BUILDING SERVICE)	WATTS LF957-QT	-	-	3"	-	AIR GAP FITTING, WILKINS AG	FURNISHED BY UNIVERSITY INSTALLED BY CONTRACTOR	
RPZ-2	REDUCED PRESSURE ZONE BACKFLOW PREVENTER W/ QUARTER TURN BALL VALVES, LEAD FREE (HEATING HW MAKEUP)	WATTS LF009-QT	-	-	3/4"	-	AIR GAP FITTING, WILKINS AG	-	
SH-1	ADA COMPLIANT SHOWER, SOLID SURFACE SHOWER RECEPTOR WITH INTEGRAL REAR TRENCH DRAIN, 36"x36"INTERIOR, COLOR: PROVIDE STANDARD COLOR OPTIONS	WILLOUGHBY INDUSTRIES AQUASURF AS-S3636ADA	2"	1-1/2"	1/2"	1/2"	SHOWER VALVE (1.5GPM), STANDARD HEAD	SHOWER SYSTEM MOEN 8375EP15	
SK-1	STAINLESS STEEL SERVICE SINK, 12"HIGH BACKSPLASH	ELKAY ESSB2520C	1-1/2"	1-1/2"	1/2"	1/2"	WALL BRACKET, FAUCET, SS STRAINERS, SUPPLIES, STOPS, CAST IRON TRAP, TAILPIECE, AND ESCUTCHEON PLATE	FAUCETS WITH VACUUM BREAKER: TWO LEVER, BACKSLASH MOUNTED ELKAY MODEL LK940BR03L2H	
SK-2	SINGLE BOWL STAINLESS STEEL DROP-IN SINK, 3 HOLES 4"OC, 22"x19 1/2"x5 1/2" DEEP	ELKAY LRAD2219	1-1/2"	1-1/2"	1/2"	1/2"	FAUCET, SS STRAINERS, SUPPLIES, STOPS, TRAP, TAILPIECE, AND ESCUTCHEON PLATE	FAUCETS: SINGLE LEVER, 1.5GPM CHICAGO MODEL 2300-8E34VPABCP	
TMV-1	THERMOSTATIC MIXING VALVE, HI/LO MASTER, ROUGH BRONZE BODY (MASTER)	POWERS LFSH1432	-	-	3/4"	3/4"	INSTALL COMBINATION PRESSURE AND TEMPERATURE GAUGE ON HW INLET AND OUTLET	5PSI DROP @19 GPM	
TPV	TRAP PRIMER VALVE	MIFAB MI-DU-500	<u>-</u>	_	1/2"	_	-	-	
UR-1	ADA COMPLIANT, URINAL, WALL MOUNTED, VITREOUS CHINA, 0.125GPF	KOHLER BARDON K-4904-ET	2"	2"	3/4"	-	HYDROPOWER SELF-GENERATING SYSTEM SENSOR FLUSH VALVE, CARRIER	TOTO ECOPOWER FLUSH VALVE. TEU1UA, 0.128 GPF WITH MANUAL OVER RIDE	
UR-2	URINAL, WALL MOUNTED, VITREOUS CHINA, 0.125GPF	KOHLER BARDON K-4904-ET	2"	2"	3/4"	-	HYDROPOWER SELF-GENERATING SYSTEM SENSOR FLUSH VALVE, CARRIER	TOTO ECOPOWER FLUSH VALVE. TEU1UA, 0.128 GPF WITH MANUAL OVER RIDE	
WC-1	ADA COMPLIANT, WATER CLOSET, FLUSH VALVE, WALL MOUNTED, TOP SPUD, VITREOUS CHINA, 1.28GPF	KOHLER KINGSTON K-4325	4"	2"	1"	-	HYDROPOWER SELF-GENERATING SYSTEM SENSOR FLUSH VALVE & OPEN FRONT SEAT, CARRIER	TOTO HIGH EFFICIENCY ECOPOWER FLUSH VALVE TET1LA, 1.28 GPF WITH MANUAL OVER RIDE	
WC-2	WATER CLOSET, FLUSH VALVE, WALL MOUNTED, TOP SPUD, VITREOUS CHINA, 1.28GPF	KOHLER KINGSTON K-4325	4"	2"	1"	-	HYDROPOWER SELF-GENERATING SYSTEM SENSOR FLUSH VALVE & OPEN FRONT SEAT, CARRIER	TOTO HIGH EFFICIENCY ECOPOWER FLUSH VALVE TET1LA, 1.28 GPF WITH MANUAL OVER RIDE	
wco	WALL CLEANOUT, BRONZE PLUG AND SS ACCESS COVER	MIFAB C1430	VARIES	-	-	-	-	SIZE TO MATCH SANITARY LINE SIZE, MAXIMUM 4"	
WH-1	WALL HYDRANT, ENCASED NON-FREEZE, SATIN NICKEL BRONZE BOX, HINGED WITH LOCKING COVER	MIFAB MHY-20	_	_	3/4"	-	-	-	
WHA	WATER HAMMER ARRESTOR, PISTON OPERATED	MIFAB MWH	_	-	VARIES	-	-	NO ACCESS DOOR REQUIRED	

#### **BLACKSBURG TRANSIT**

**BUILDING ADDRESS** 1324 PERRY STREET, BLACKSBURG, VA 24060

#### **MULTI-MODAL TRANSIT FACILITY**

**BID SET** 





www.wendelcompanies.com p:703.299.8718 tf:877.293.6335 ARCHITECTURE● ENGINEERING● PLANNING ENERGY SERVICES● CONSTRUCTION MANAGEMENT




NOTE:
THIS DOCUMENT, AND THE IDEAS AND DESIGNS INCORPORATED HEREIN, AS AN INSTRUMENT OF PROFESSIONAL SERVICE, IS THE PROPERTY OF THE ARCHITECT AND ENGINEER AND IS NOT TO BE USED IN WHOLE OR IN PART, FOR ANY OTHER PROJECT WITHOUT THE WRITTEN AUTHORIZATION OF THE ARCHITECT AND ENGINEER. UNAUTHORIZED ALTERATION OR ADDITION TO ANY SURVEY DRAWING, DESIGN, SPECIFICATION, PLAN OR REPORT IS PROHIBITED IN ACCORDANCE WITH STATE LAW, CODE AND RULES.

DAA Project No. B10172B-05

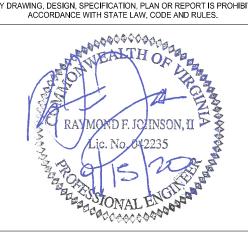

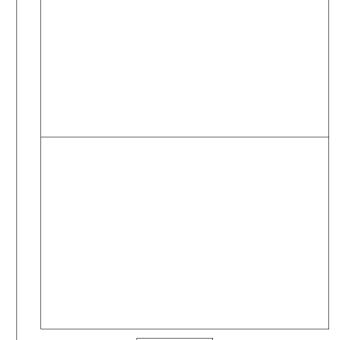

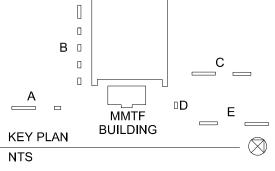

DWG. TITLE

DWG. No.

PLUMBING SCHEDULES

DATE SEPTEMBER 15, 2020 SCALE NONE DWN. TIP снк. CRL PROJ. No. 449803